

ABBREVIATIONS LIST

THE FOLLOWING TABLE OF ABBREVIATIONS IS FOR THE CONVENIENCE OF THE CONTRACTOR AND MAY NOT INCLUDE ALL ABBREVIATIONS USED IN THE CONSTRUCTION DOCUMENTS. THE CONTRACTOR SHALL PROMPTLY CONTACT THE ARCHITECT IF CLARIFICATIONS OR INTERPRETATION OF THESE OR ANY ABBREVIATIONS USED IN THE CONSTRUCTION DOCUMENTS IS REQUIRED.

A/C	AIR CONDITIONING	LAM	LAMINATE
A/E	ARCHITECT/ENGINEER	LAV	LAVATORY
AB	ANCHOR BOLT	LF	LINEAR FEET (FOOT)
ACC	ACCESSIBLE	LH	LEFT HAND
ACT	ACOUSTICAL CEILING TILE	LOC	LOCATION
ADA	AMERICANS W/ DISABILITIES ACT	LT	LIGHT
AFF	ABOVE FINISHED FLOOR	LVR	LOUVER
AHU	AIR HANDLING UNIT		
AIB	AIR INFILTRATION BARRIER	MANUF	MANUFACTURER
ALT	ALTERNATE	MATL	MATERIAL
ALUM	ALUMINUM	MAX	MAXIMUM
APPROX	APPROXIMATE	MECH	MECHANICAL
AVG	AVERAGE	MEMB	MEMBRANE
		MFR	MANUFACTURER
BD	BOARD	MID	MIDDLE
BDRY	BOUNDARY	MIN	MINIMUM
BIT	BITUMINOUS	MISC	MISCELLANEOUS
BLDG	BUILDING	MO	MASONRY OPENING
BLKG	BLOCKING	MR	MOISTURE RESISTANT
BO	BOTTOM OF	MTG	MOUNTING
BOS	BOTTOM OF STEEL	MTL	METAL
BOT	BOTTOM		
BSMT	BASEMENT	NA	NOT APPLICABLE
		NIC	NOT IN CONTRACT
		NO	NUMBER
CCSPF	CLOSED CELL SPRAY POLYURETHANE FOAM	NOM	NOMINAL
CAB	CABINET	NRC	NOISE REDUCTION COEFFICIENT
CBB	CEMENTITIOUS (BACKER) BOARD	NTS	NOT TO SCALE
CD	CONSTRUCTION DOCUMENTS		
CM	CONSTRUCTION MANAGER		
CFM	CUBIC FEET PER MINUTE	OC	ON CENTER
CFMF	COLD-FORMED METAL FRAMING	OD	OUTSIDE DIAMETER
CIP	CAST-IN-PLACE	O/O	OUTSIDE TO OUTSIDE
CJ	CONTROL JOINT	OH	OPPOSITE HAND
CL	CENTER LINE	OPNG	OPENING
CLG	CEILING	OPP	OPPOSITE
CLR	CLEAR	OWSJ	OPEN WEB STEEL JOIST
CMU	CONCRETE MASONRY UNIT	ORIG	ORIGINAL
CO	CLEANOUT		
COL	COLUMN	PAT	PATTERN
COMM	COMMUNICATION	PBD	PARTICLEBOARD
CONC	CONCRETE	PCF	POUNDS PER CUBIC FOOT
CONT	CONTINUOUS	PD	PAPER TOWEL DISPENSER
COORD	COORDINATE	PERF	PERFORATED
CPT	CARPET	PERIM	PERIMETER
CSWK	CASEWORK	PLAM	PLASTIC LAMINATE
CT	CERAMIC TILE	PLBG	PLUMBING
CUH	CABINET UNIT HEATER	PLYWD	PLYWOOD
		PNL	PANEL
DBL	DOUBLE	PRKG	PARKING
DEMO	DEMOLITION	PSF	POUNDS PER SQUARE FOOT
DEPT	DEPARTMENT	PSI	POUNDS PER SQUARE INCH
DETL	DETAIL	PT	PRESSURE TREATED
DIA	DIAMETER	PTD	PAINTED
DIM	DIMENSION	PTN	PARTITION
DIST	DISTANCE	PVC	POLY VINYL CHLORIDE
DK	DECK	PWR	POWER
DN	DOWN		
DW	DISHWASHER	QT	QUARRY TILE
DWG	DRAWING	QTY	QUANTITY
DF	DRINKING FOUNTAIN		
		RB	RESILIENT BASE
EA	EACH	RBR	RUBBER
EAF	EACH FACE	RCP	REFLECTED CEILING PLAN
EIFS	EXTERIOR INSULATION & FINISH SYSTEM	RD	ROOF DRAIN
EJ	EXPANSION JOINT	REC	RECESSED
EL	ELEVATION	REQD	REQUIRED
ELEV	ELEVATOR	RFG	ROOFING
EPS	EXPANDED POLYSTYRENE BOARD	RH	RIGHT HAND
EQ	EQUAL	RHR	RIGHT HAND REVERSE
EQUIP	EQUIPMENT	RM	ROOM
EXST	EXISTING	RO	ROUGH OPENING
ETR	EXISTING TO REMAIN		
EXTR	EXTERIOR	SAFF	SELF-ADHESIVE FLEXIBLE FLASHING
		SCHED	SCHEDULE
FA	FIRE ALARM	SF	SQUARE FOOT (FEET)
FAAP	FIRE ALARM ANNUNCIATOR PANEL	SFTWD	SOFTWOOD
FD	FLOOR DRAIN	SG	SINGLE
FDN	FOUNDATION	SHTHG	SHEATHING
FE	FIRE EXTINGUISHER	SIM	SIMILAR
FEC	FIRE EXTINGUISHER CABINET	SJ	SCORED JOINT
FF	FINISH FACE	SND	SANITARY NAPKIN DISPENSER
FFE	FINISH FLOOR ELEVATION	SFD	SOAP DISPENSER
FBGL	FIBERGLASS	SP EL	SPOT ELEVATION
FIN	FINISH	SPEC	SPECIFICATION
FIXT	FIXTURE	SQ	SQUARE
FLEX	FLEXIBLE	SQ IN	SQUARE INCH
FLG	FLOORING	SQ YD	SQUARE YARD
FLR	FLOOR	SST	STAINLESS STEEL
FOC	FACE OF CONCRETE	STRS	STAIRS
FOM	FACE OF MASONRY	STD	STANDARD
FRG	FIBER REINFORCED GYPSUM	STL	STEEL
FRMG	FRAMING	STOR	STORAGE
FRP	FIBERGLASS REINFORCED PLASTIC	STRL	STRUCTURAL
FRTW	FIRE RETARDANT TREATED WOOD	SUSP	SUSPENDED
FT	FEET	SV	SHEET VINYL
FTG	FOOTING		
		TBD	TO BE DETERMINED
GA	GAUGE	TD	TRENCH DRAIN
GALV	GALVANIZED	TEL	TELEPHONE
GB	GRAB BAR	TEMP	TEMPORARY
GC	GENERAL CONTRACTOR	TFF	TOP OF FINISH FLOOR
GWB	GYPSUM WALL BOARD	T&G	TONGUE AND GROOVE
GYP	GYPSUM	THK	THICKNESS
		TO	TOP OF
HB	HOSE BIBB	TOF	TOP OF FOOTING
HC	HANDICAPPED	TOM	TOP OF MASONRY
HD	HAND DRYER	TOS	TOP OF SLAB
HDPE	HIGH DENSITY POLYETHYLENE	TOW	TOP OF WALL
HDW	HARDWARE	TPD	TOILET PAPER DISPENSER
HDWD	HARDWOOD	TYP	TYPICAL
HM	HOLLOW METAL		
HORIZ	HORIZONTAL	UC	UNDERCUT
HGT	HEIGHT	UON	UNLESS OTHERWISE NOTED
HVAC	HEATING, VENTILATION AND AIR CONDITIONING		
		VB	VAPOR BARRIER
ID	INSIDE DIAMETER	VFY	VERIFY
INCL	INCLUDE (ING)	VIF	VERIFY IN FIELD
INSUL	INSULATION	VCT	VINYL COMPOSITION TILE
INTR	INTERIOR		
INV	INVERT	W/	WITH
		W/O	WITHOUT
JAN	JANITOR	WC	WATER CLOSET
JST	JOIST	WD	WOOD
KPD	KEYPAD		
KPL	KICKPLATE		

SYMBOLS LEGEND

	ROOM NAME	ROOM TAG
	CEILING TYPE AND ELEVATION AFF	
	WALL TYPE	
	COLUMN BUBBLE	
	KEY NOTE SYMBOL	
	WINDOW SYMBOL	
	DOOR SYMBOL	
	ACCESSORY TAG	
	TARGET ELEVATION MARKER	
	EXTERIOR ELEVATION SYMBOL	
	INTERIOR ELEVATION SYMBOL	
	SECTION MARKER	
	DETAIL CALLOUT	
	REVISION CALLOUT	

GRAPHICS LEGEND

	GYPSUM WALL BOARD
	PLYWOOD
	CEMENT BOARD
	CONCRETE
	GLUE-LAMINATED LUMBER
	GRAVEL
	ASPHALT SHINGLES
	SPRAY FOAM INSUL (TYPES 4 & 6)
	RIGID INSUL (TYPES 1 & 7)
	RIGID INSUL (TYPE 8)
	DENS PAK INSUL (TYPE 9)
	LOOSE FILL INSUL (TYPE 2)
	BATT INSUL (TYPES 3 & 5)

BELKNAP COUNTY COURTHOUSE


30 COUNTY DR, LACONIA, NH
INTERIOR RENOVATIONS

DESIGN DEVELOPMENT
OCTOBER 18, 2023

PROJECT TEAM:



SHEERR McCRYSTAL PALSON ARCHITECTURE INC.
30 S. MAIN ST., BLDG 2
CONCORD, NH 03301-4809
Phone: (603) 228-8880
www.sheerr.com

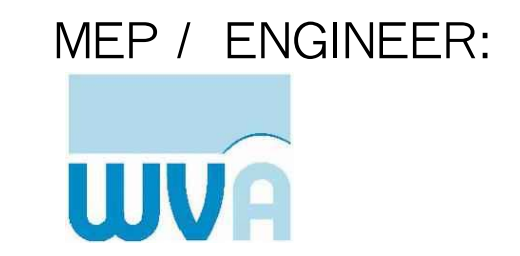

WV Engineering Associates PA
11 King Court
Keene, NH 03431
Phone: (603) 352-7007



TF Moran Inc.
48 Constitution Drive
Bedford, NH 03110
Phone: (603) 472-4488

PROJECT SUMMARY:

THE PROJECT CONSISTS OF A RENOVATION OF THE EXISTING LOWER LEVEL OF THE COUNTY COURTHOUSE.
GENERAL SCOPE OF WORK INCLUDES, BUT IS NOT LIMITED TO:

- SELECTED DEMOLITION
- METAL STUD FRAMING AND DRYWALL
- DOORS & FRAMES
- MECHANICAL, ELECTRICAL, FIRE PROTECTION
- INTERIOR CASEWORK, MILLWORK
- INTERIOR LED LIGHTING
- INTERIOR PAINTING

DRAWING INDEX:

COVERSHEET			
Architectural		Mechanical	
A001	SUMMARY, NOTES, ABBEVIATIONS & LEGENDS	M001	GENERAL MECHANICAL NOTES
A002	CODE REVIEW, ASSEMBLY TYPES & NOTES	M002	
AD100	BASEMENT LEVEL DEMOLITION PLAN	M003	
AD101	FIRST FLOOR DEMOLITION PLAN	M004	
A100	BASEMENT LEVEL PLAN	M101	
A101	FIRST FLOOR PLAN	M102	
A110	REFLECTED CEILING PLANS	M103	
A410	STAIR PLANS & SECTIONS	M104	
A600	DOOR & WINDOW SCHEDULES & NOTES	M105	
A700	ENLARGED PLANS & INTERIOR ELEVATIONS	M106	
A800	MILLWORK DETAILS	M107	
Electrical		Plumbing	
E001	GENERAL ELECTRICAL NOTES	P001	GENERAL PLUMBING NOTES
E002		P002	
E003		P003	
E004		P004	
E101		P101	
E102		P102	
E103		P103	
E104		P104	
E105		P105	
Fire Protection			
S001	GENERAL FIRE PROTECTION NOTES		
S002			
S003			
S004			

LOCATION MAP:


Progress
Print Not For
Construction

ABBREVIATIONS LIST


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CLG	CEILING	OVSJ	OPEN WEB STEEL JOIST
CLR	CLEAR	ORIG	ORIGINAL
CMU	CONCRETE MASONRY UNIT	PAT	PATTERN
CO	CLEANOUT	PBD	PARTICLEBOARD
COL	COLUMN	PCC	PRECAST CONCRETE
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FA	FIRE ALARM	SFTWD	SOFTWOOD
FALAP	FIRE ALARM ANNUNCIATOR PANEL	SGL	SINGLE
FD	FLOOR DRAIN	SHTHG	SHEATHING
FNDN	FOUNDATION	SIM	SIMILAR
FE	FIRE EXTINGUISHER	SJ	SCORED JOINT
FEC	FIRE EXTINGUISHER CABINET	SND	SANITARY NAPKIN DISPENSER
FF	FINISH FACE	SPD	SOAP DISPENSER
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FIBGL	FIBERGLASS	SPEC	SPECIFICATION
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FOC	FACE OF CONCRETE	STD	STANDARD
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FRG	FIBER REINFORCED GYPSUM	STOR	STORAGE
FRMG	FRAMING	STR	STRUCTURAL
FRP	FIBERGLASS REINFORCED PLASTIC	SUSP	SUSPENDED
FRTW	FIRE RETARDANT TREATED WOOD	SV	SHEET VINYL
FT	FEET	TBD	TO BE DETERMINED
FTG	FOOTING	TD	TRENCH DRAIN
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GALV	GALVANIZED	TEMP	TEMPORARY
GB	GRAB BAR	TFF	TOP OF FINISH FLOOR
GC	GENERAL CONTRACTOR	THK	TONGUE AND GROOVE THICKNESS
GWB	GYPSUM WALL BOARD	TO	TOP OF
GYP	GYPSUM	TOF	TOP OF FOOTING
HB	HOSE BIBB	TOM	TOP OF MASONRY
HC	HANDICAPPED	TOS	TOP OF SLAB
HD	HAND DRYER	TOW	TOP OF WALL
HDPE	HIGH DENSITY POLYETHYLENE	TPD	TOILET PAPER DISPENSER
HDW	HARDWARE	TYP	TYPICAL
HDWD	HARDWOOD	UC	UNDERCUT
HM	HOLLOW METAL	UON	UNLESS OTHERWISE NOTED
HORIZ	HORIZONTAL	VB	VAPOR BARRIER
HGT	HEIGHT	VFY	VERIFY
HVAC	HEATING, VENTILATION AND AIR CONDITIONING	VIF	VERIFY IN FIELD
ID	INSIDE DIAMETER	VCT	VINYL COMPOSITION TILE
INCL	INCLUDE (ING)	W/	WITH
INSUL	INSULATION	W/O	WITHOUT
INTR	INTERIOR	WC	WATER CLOSET
INV	INVERT	WD	WOOD
JAN	JANITOR		
JST	JOIST		
KPD	KEYPAD		
KPL	KICKPLATE		


SYMBOLS LEGEND

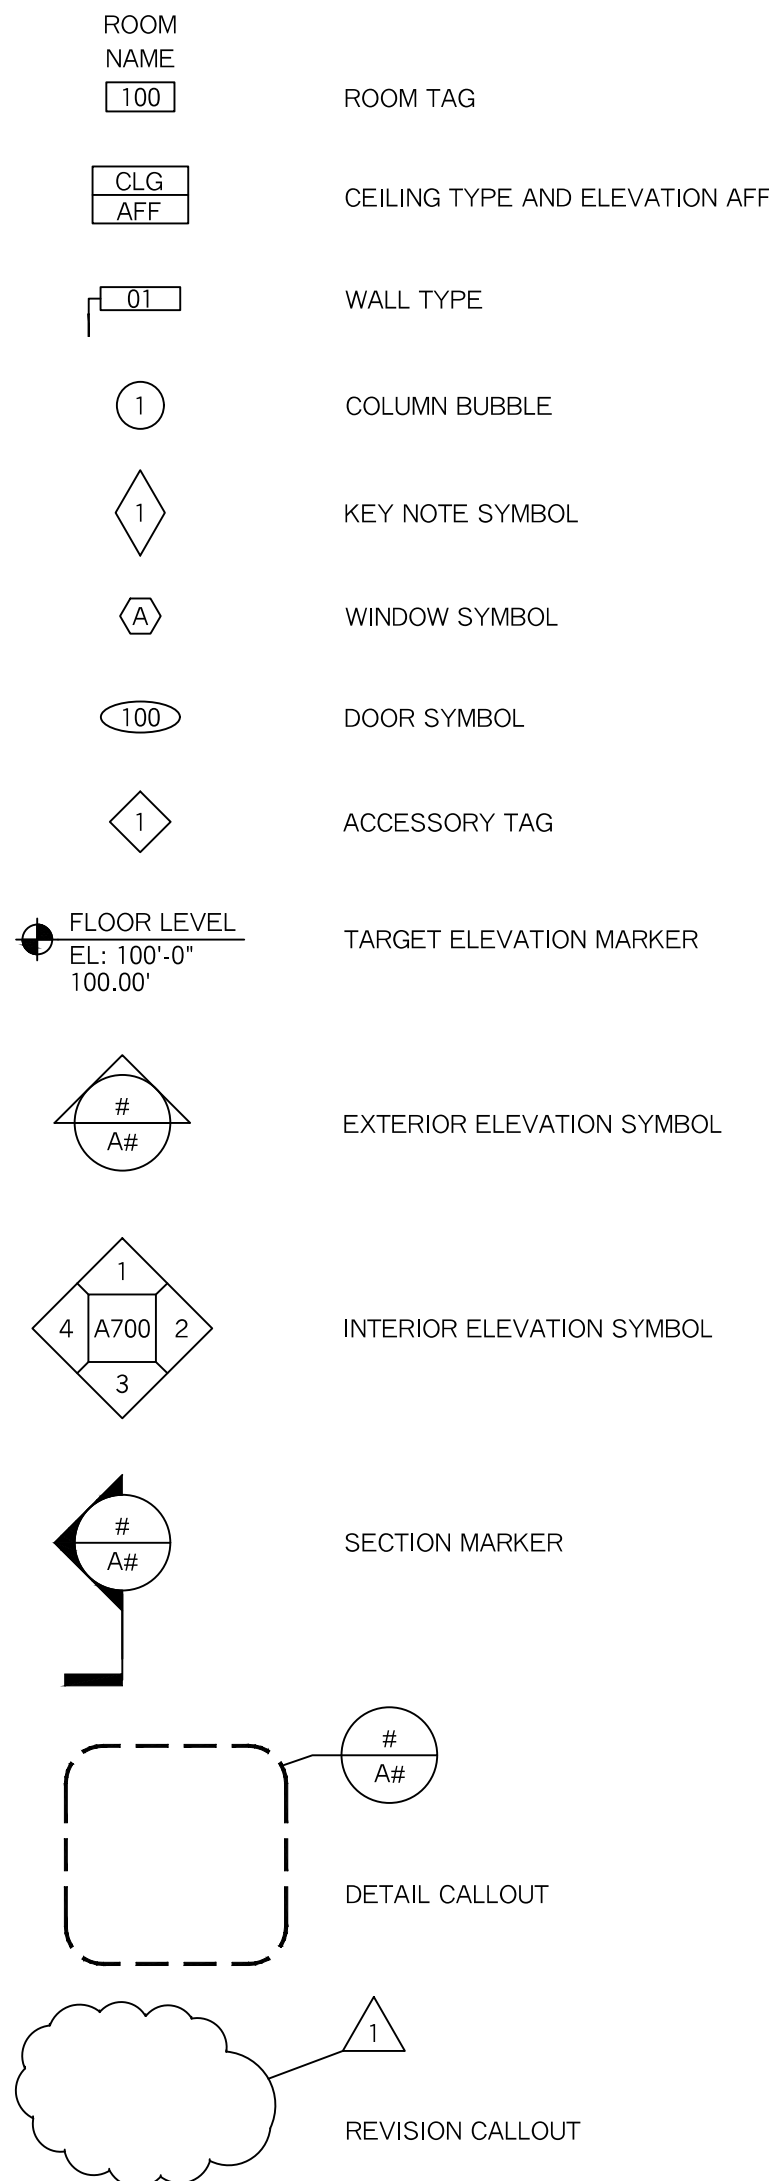

GRAPHICS LEGEND

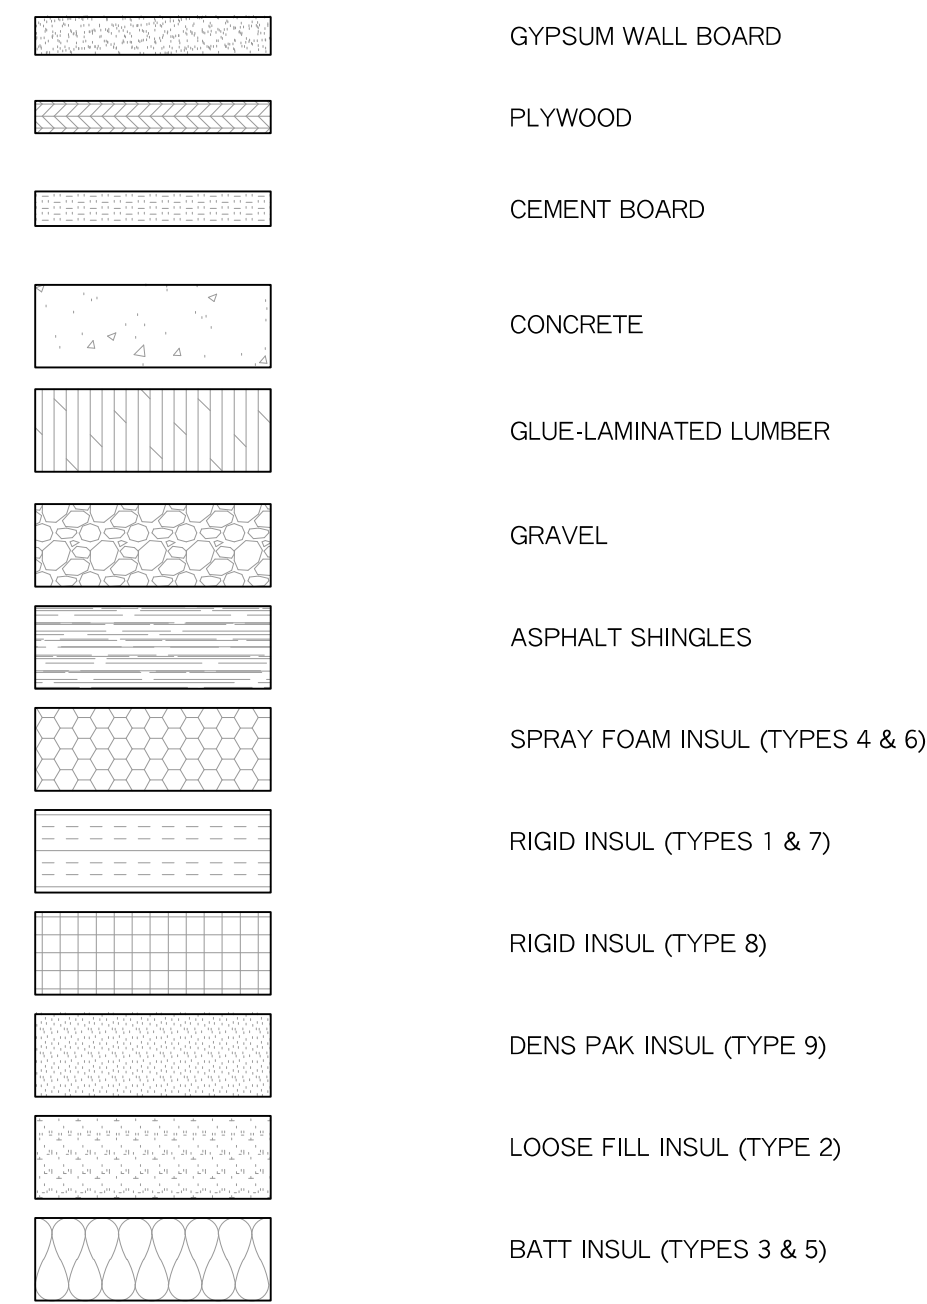

SIGNAGE NOTES

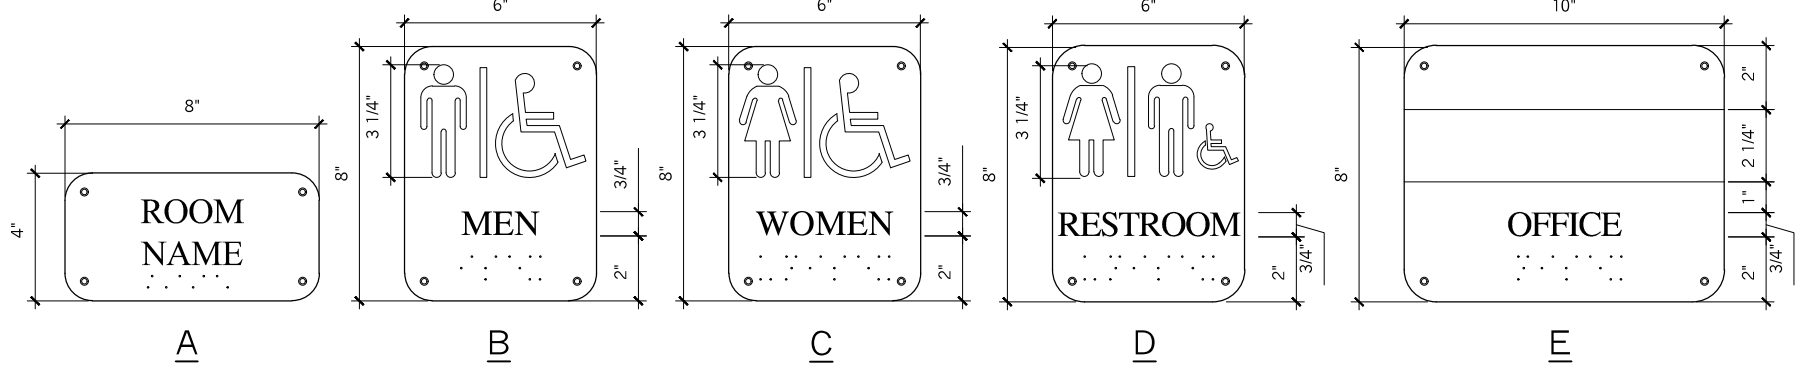


- ALL SIGNS WITH COORDINATED BRAILLE AND ROOM NAME SHALL BE TAKEN FROM THE FINISH SCHEDULE "ROOM NAME" DESIGNATIONS. OWNER TO VERIFY FINAL SIGN TEXT.
- UNLESS OTHERWISE NOTED, OR MORE SPECIFICALLY DEFINED IN THE WRITTEN SPECIFICATIONS, PROVIDE ONE SIGN PER INTERIOR DOORWAY. PROVIDE TWO SIGNS FOR DOORS IN PATHS OF TRAVEL (IE HALLS).
- LETTERING TO BE RAISED THICKNESS 3/16" HIGH IN TIMES NEW ROMAN FONT. COLOR AS SELECTED FROM MAN. FULL RANGE
- SIGNS TO BE PHOTOPOLYMER W/ SCREEN, RAISED COPY AND GRADE II BRAILLE. CHEMICALLY WELDED LETTERS AND INSET BRAILLE ARE NOT ALLOWED. FINAL COLOR T.B.D. INSTALLATION WILL BE TAMPER PROOF SCREWS WITH FULL PERIMETER DOUBLE FACED TAPE WHERE REQUIRED.
- SEE PLANS, INTERIOR ELEVATIONS, AND MILLWORK DRAWINGS FOR LOCATIONS OF SIGNAGE NOT ASSOCIATED WITH DOORS.

PROJECT SUMMARY

THE PROJECT CONSISTS OF A NEW # STORY, _____ SQ.FT (BUILDING PURPOSE). STRUCTURE SHALL CONSIST OF STRL SYSTEM WITH ROOF STRL SYSTEM. TOTAL BUILDING AREA = APPROXIMATELY ##,### SQ. FT.




GENERAL SCOPE OF WORK INCLUDES, BUT IS NOT LIMITED TO:

- EXCAVATION, SITEWORK UNDERGROUND UTILITIES
- FOUNDATION TYPE
- FRAMING TYPE
- ROOF STRL SYSTEM
- ATTIC INSULATION SYSTEM
- WINDOWS, DOORS FRAMES AND HARDWARE
- CASEWORK
- INTERIOR FINISHES
- LIGHTING, POWER, AND DATA DISTRIBUTION
- HVAC SYSTEMS, SUPPLY AND RETURN DUCTWORK & ASSOC. PIPING
- PLUMBING FIXTURES & ASSOC. PIPING
- SPRINKLER SYSTEM

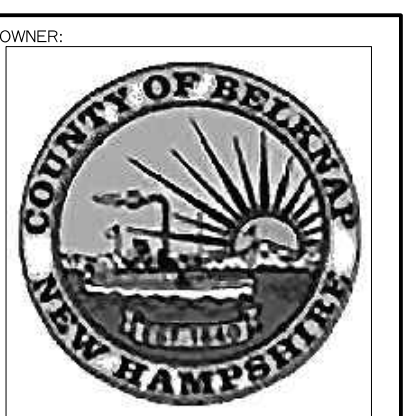


MEP ENGINEER: WY Engineering Assoc., PA
 1100 State St
 Laconia, NH 03246
 www.wyee.com

PHONE: 603.228.8880
 WWW.SHEER.COM

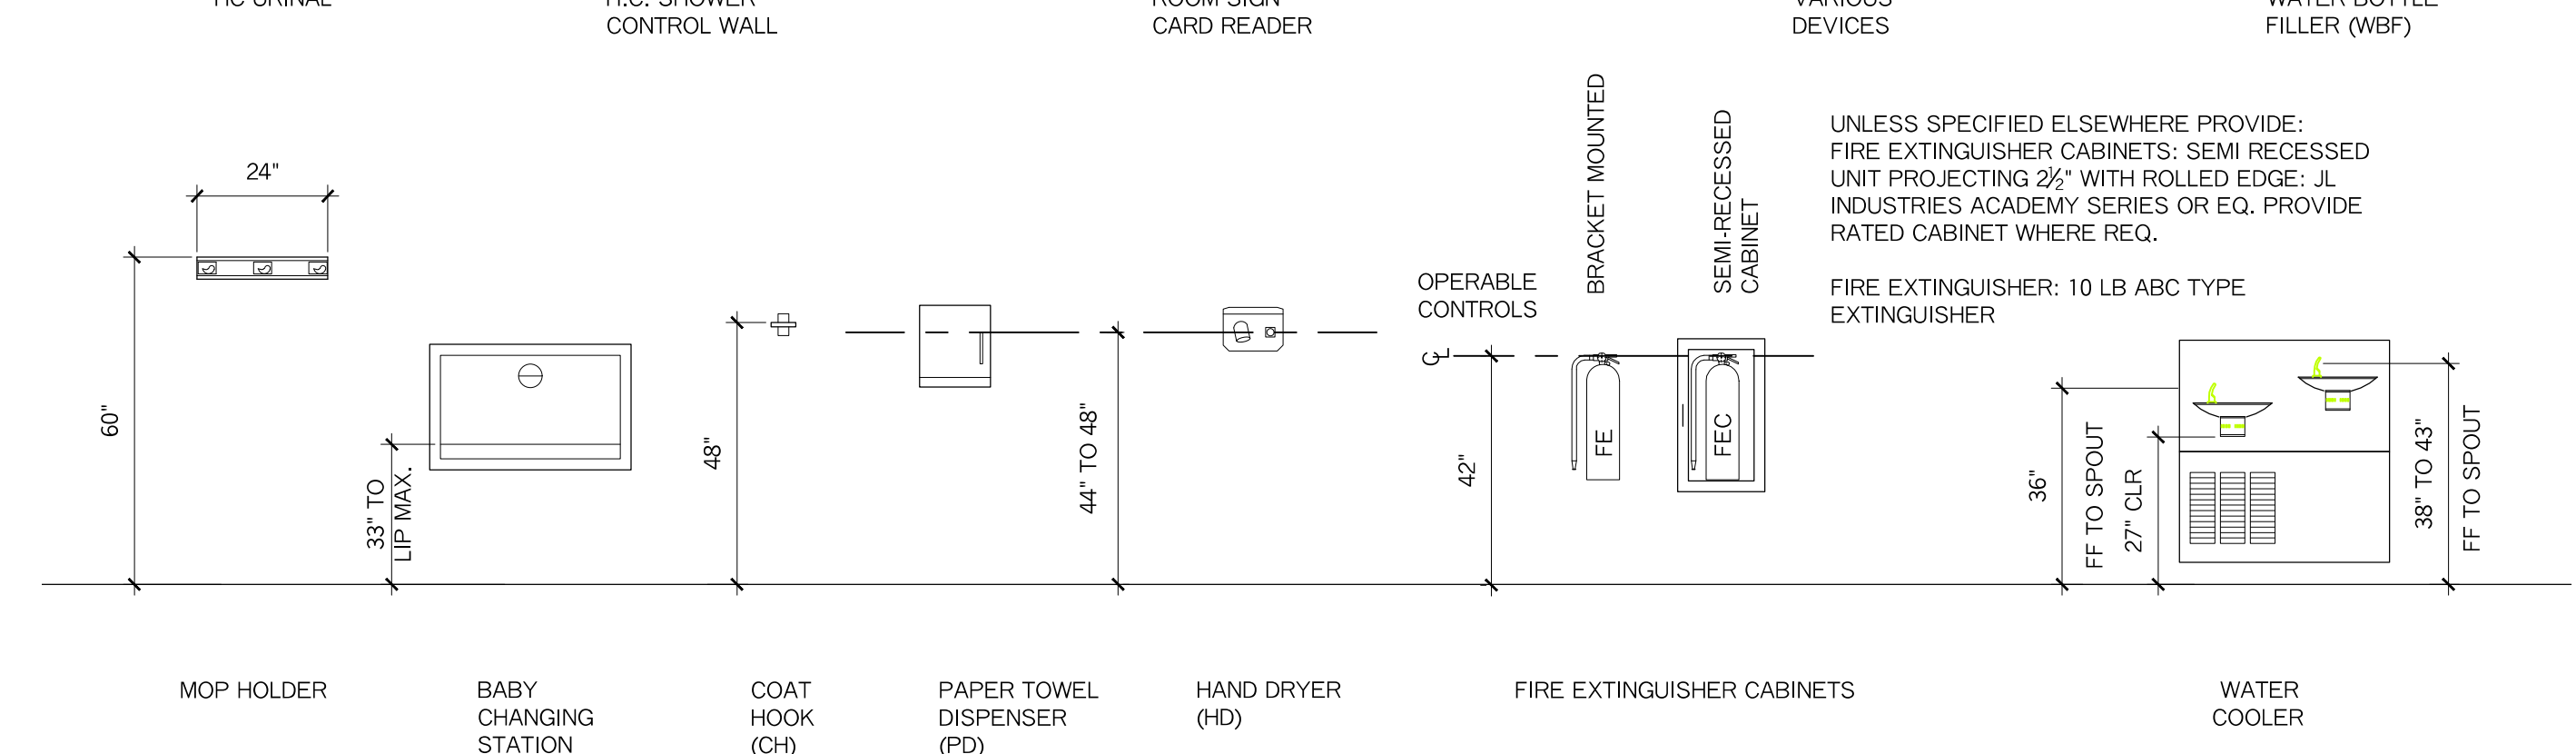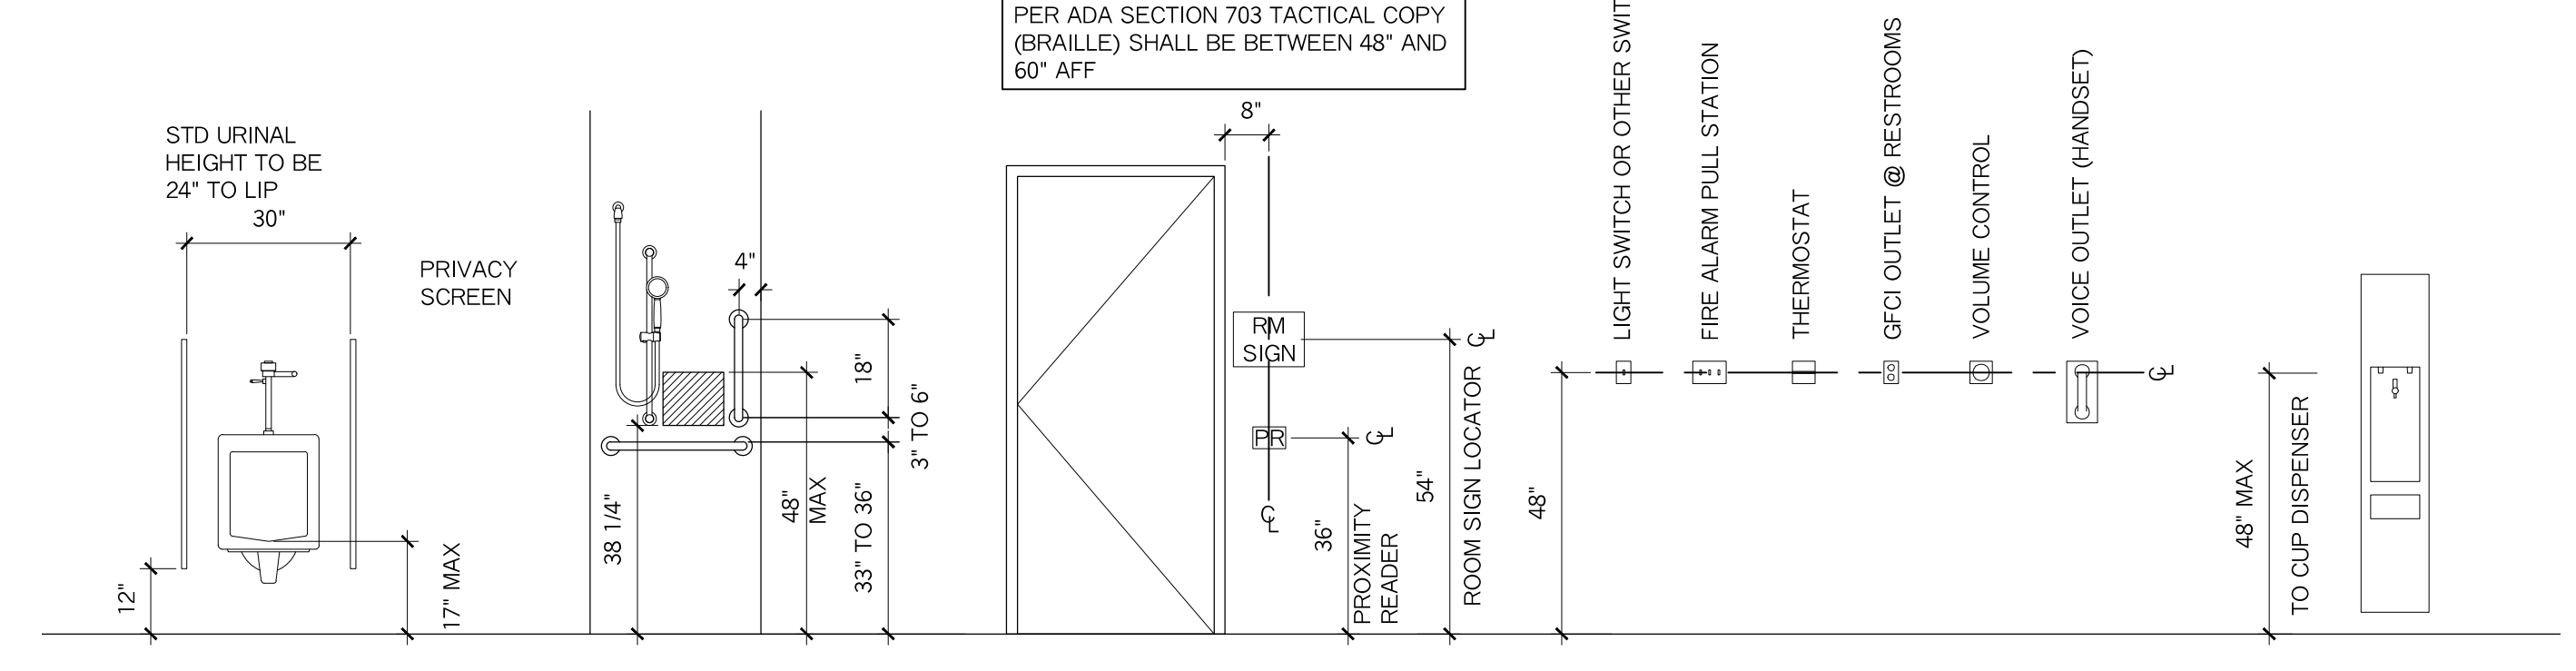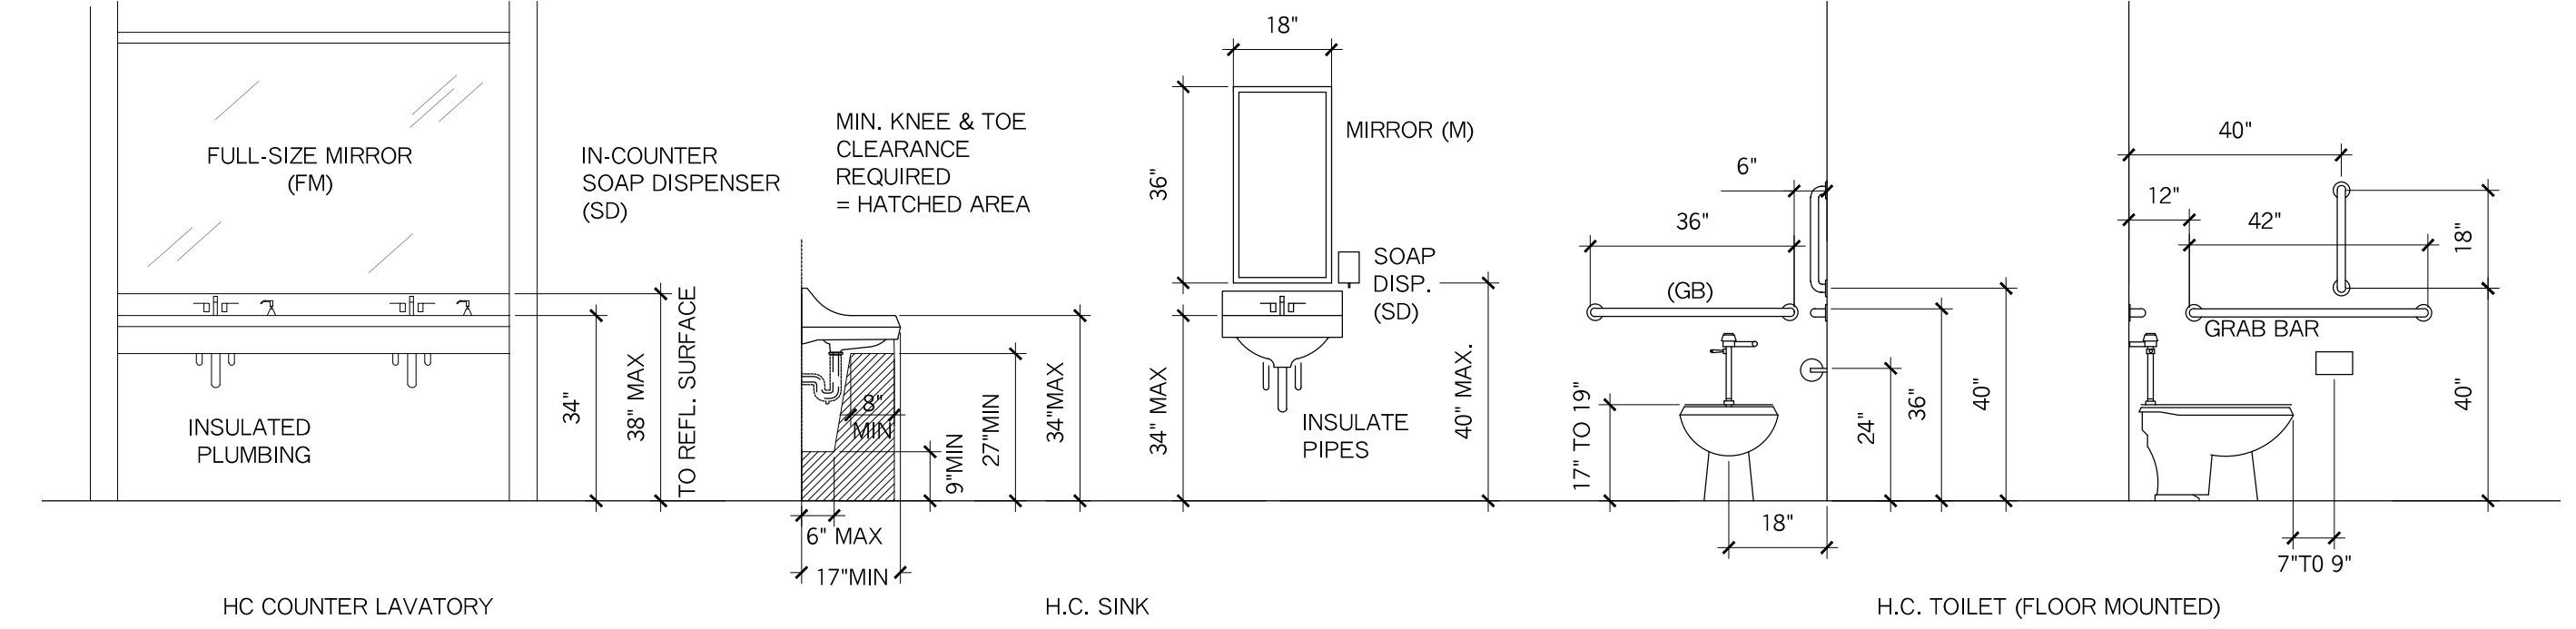

ADA MOUNTING HEIGHTS

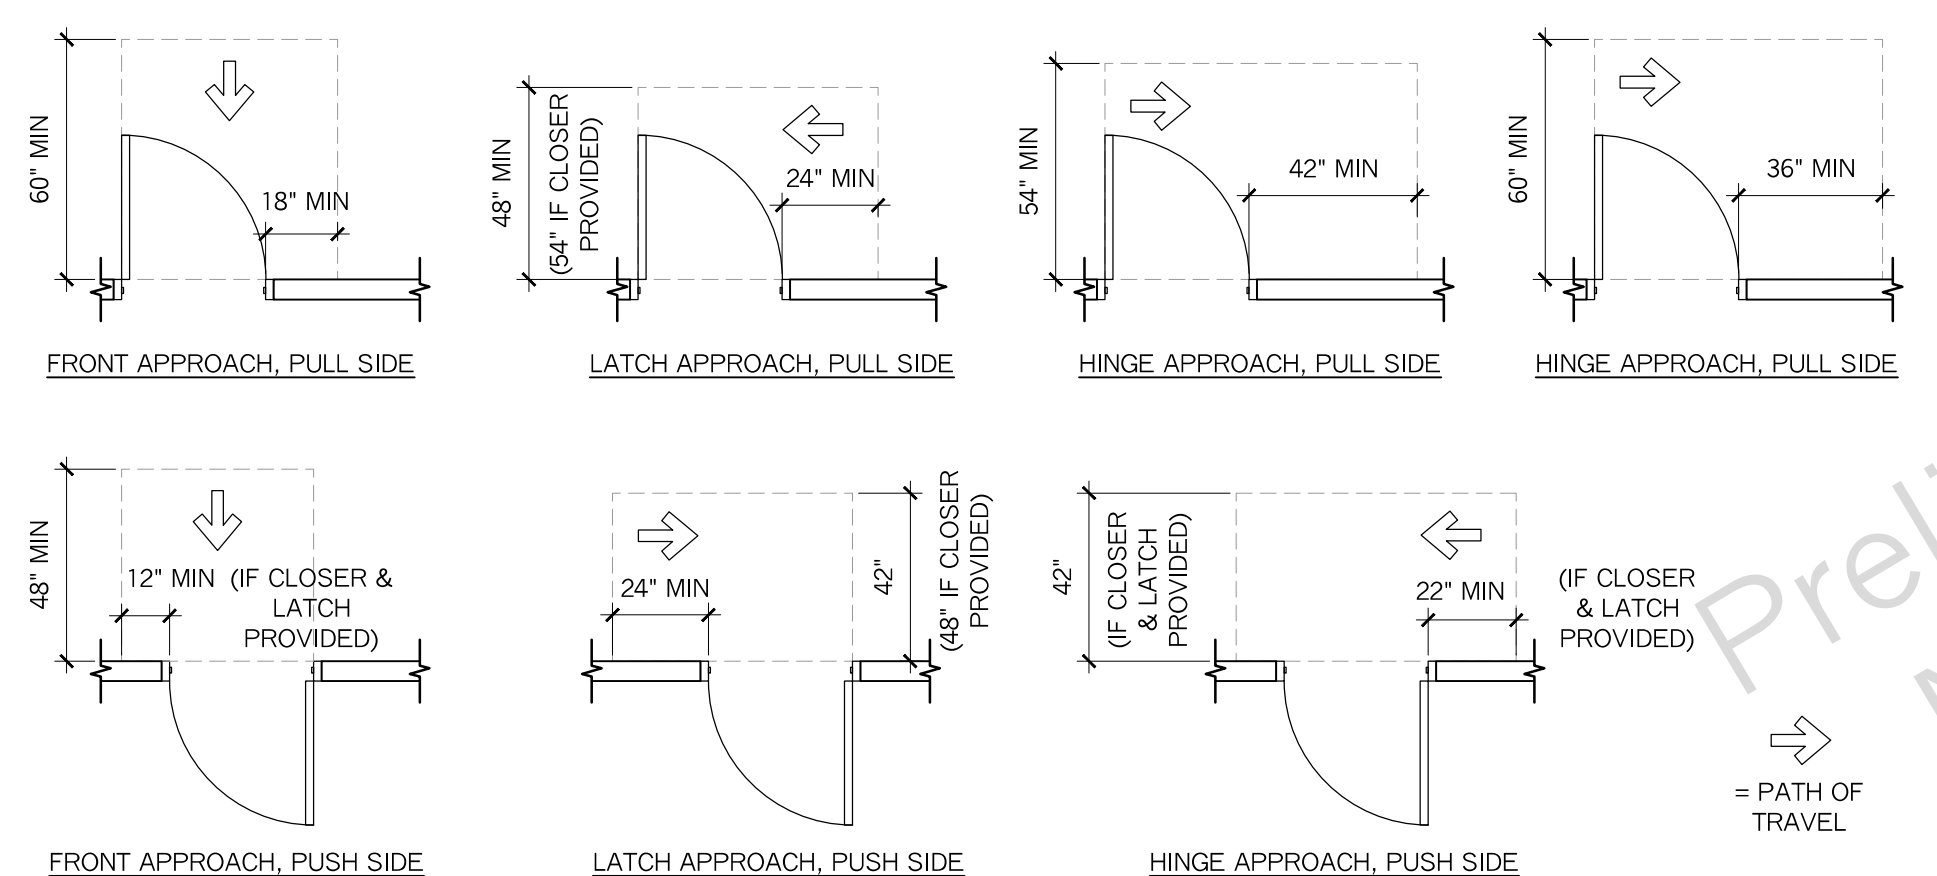

ADA DOOR CLEARANCE REQUIREMENTS

BELKNAP COUNTY SUPERIOR COURT
 64 Court St # 5, Laconia, NH 03246

Interior Renovations

PROJECT SUMMARY, ABBREVIATIONS & LEGENDS

PROJECT: BELKNAP COUNTY SUPERIOR COURT
 JOB NO: 23-011
 DRAWN BY: V.A.D.
 CHECKED BY: A.M.
 DATE: OCTOBER 09, 2023

ISSUED: DESIGN DEVELOPMENT

REVISION: DATE


SHEET NUMBER: **A001**

© 2023 SMP ARCHITECTURE

BUILDING CODE COMPLIANCE SUMMARY			
GENERAL PROJECT INFO			
PROJECT #	23-011		
PROJECT DESCRIPTION:	INTERIOR RENOVATIONS TO AN EXISTING BUILDING		
BUILDING AREA:	6,144 SQ. FT. AFFECTED AREA		
APPLICABLE CODES			
BUILDING CODE:	2018 INTERNATIONAL BUILDING CODE		
LIFE SAFETY CODE:	NFPA 101, 2015 (through State Fire Code Saf-C 6000)		
ENERGY CODE:	IECC 2015		
ACCESSIBILITY:	ADA 2010, 521 CMR		
OCCUPANCY/USE GROUPS			
GROUP:	B (BUSINESS)		CODE CITATION IBC CH 3, NFPA CH 6
CONSTRUCTION TYPE			
5B (IBC DESIGNATION)	EXISTING CONSTRUCTION / TYPE 5B - SPRINKLERED		IBC TABLE 601
V (000) (NFPA DESIGNATION)			NFPA 101 TABLE 12.1.6
OCCUPANT LOAD			
AREA PER UNIT: = 6,144 SF	B = 150 GSF / PERSON = 41 OCCUPANTS		IBC 1004.1.1, NFPA 7.3.1.2
REQUIRED / ALLOWED		PROPOSED	
BUILDING HEIGHT/AREA			
ALLOWABLE STORIES ABOVE GRADE	EXISTING THREE STORIES	EXISTING TO REMAIN	IBC TABLE 504.4
ALLOWABLE HEIGHT IN FEET	EXISTING	EXISTING TO REMAIN	IBC TABLE 504.3, NFPA 4.6.3
ALLOWABLE AREA IN SQUARE FEET	EXISTING	EXISTING TO REMAIN	IBC TABLE 506.2
MEANS OF EGRESS			
REQUIRED MIN. # OF EXITS	2 EXIT REQUIRED	2 EXITS PROVIDED	IBC 1006.3.2, NFPA 4.5.3.1, NFPA 7.4.1.1
REQUIRED MIN. EGRESS WIDTH	44" MIN WIDTH	44" MIN WIDTH PROVIDED	IBC 1005.3, NFPA 7.3.4.1
ALLOWABLE TRAVEL DISTANCE	300' MAX	193' TRAVEL DISTANCE PROVIDED	IBC 1017.2, NFPA Table A.7.6
MIN. ALLOWABLE CORRIDOR WIDTH	36" MIN	36" MIN PROVIDED	IBC TABLE 1020.2, NFPA CH 39
ALLOW. DEAD-END CORRIDOR LENGTH	20' MAX	N/A	IBC 1020.4, NFPA Table A.7.6
ALLOWABLE COMMON PATH OF TRAVEL	100' MAX ALLOWED	91' PROVIDED	IBC TABLE 1006.2.1, NFPA Table A.7.6
MAX. OCCUPANT LOAD PER SINGLE EXIT:	49 OCCUPANTS	21 OCCUPANTS	IBC 1106.3.2, NFPA CH 39
STAIR WIDTHS	44" MIN REQUIRED	45" PROVIDED	IBC 1105.3.1, NFPA TABLE 7.2.2.2.1.2(B)
STAIR TREADS & RISERS	7" MAX RISE, 11" MIN RUN	7" MAX RISE, 11" MIN RUN PROVIDED	IBC 1011.5, NFPA TABLE 7.2.2.2.1.1(a)
HANDRAILS	BETWEEN 34" AND 38" AFF	PROVIDED	IBC 1014.2, NFPA 7.2.2.4.1
DOOR WIDTHS	32" MIN CLEAR WIDTH	> 32" CLEAR WIDTH PROVIDED	IBC 1010.1.1, NFPA 7.2.1.2.3.2
RAMP	N/A		
FIRE RESISTANCE RATINGS			
PRIMARY STRUCTURAL FRAME	0 HOURS		
BEARING WALLS; EXTERIOR:	0 HOURS		
BEARING WALLS; INTERIOR:	0 HOURS		
PARTITIONS; EXTERIOR:	0 HOURS		IBC TABLE 601, NFPA CHAPTER 8
PARTITIONS; INTERIOR:	0 HOURS		
FLOOR CONSTRUCTION:	0 HOURS		
ROOF CONSTRUCTION:	0 HOURS		
CORRIDORS:	N/A		
STAIR ENCLOSURES:	N/A		
MECHANICAL ROOMS:	0 HOURS		
SHAFT ENCLOSURES:	N/A		IBC 713.4
FIRE PARTITIONS:	N/A		IBC 420.2
SMOKE BARRIERS:	N/A		
SMOKE PARTITIONS:	N/A		
HORIZONTAL ASSEMBLIES:	0 HOURS		
FIREBLOCKING	REQUIRED		
DRAFTSTOPPING	REQUIRED		
FLOOR OPENINGS	N/A		
OPENING PROTECTIVES			
ASSEMBLY TYPE	ASSEMBLY RATING	OPENING PROTECTIVE RATING	
FIRE WALL/BARRIER:	4 HOUR	3 HOUR	
FIRE WALL/BARRIER:	3 HOUR	3 HOUR	
FIRE WALL/BARRIER:	2 HOUR	1 1/2 HOUR	
FIRE WALL/BARRIER:	1 1/2 HOUR	1 1/2 HOUR	
SHAFTS / EXIT STAIRS:	2 HOUR	1 1/2 HOUR	
HORIZONTAL EXITS:	4 HOUR	3 HOUR	
HORIZONTAL EXITS:	3 HOUR	3 HOUR	
FIRE BARRIER:	1 HOUR	1 HOUR	
FIRE BARRIER (OTHER)	1 HOUR	45 MIN	
CORRIDOR WALLS:	1 HOUR	20 MIN	
CORRIDOR WALLS:	1/2 HOUR	20 MIN	
FIRE PARTITIONS:	1 HOUR	45 MIN	
FIRE PARTITIONS:	1/2 HOUR	20 MIN	
EXTERIOR WALLS:	2 + 3 HOUR	20 MIN	
EXTERIOR WALLS:	1 HOUR	1 1/2 HOUR	
SMOKE BARRIERS:	1 HOUR	45 MIN	
		20 MIN	
FIRE PROTECTION SYSTEMS			
SPRINKLER SYSTEM:	EXISTING	ETR SYSTEM MODIFIED	IBC 420.5
FIRE ALARM SYSTEM:	EXISTING	ETR FIRE ALARM SYSTEM MODIFIED	IBC 420.6
PORTABLE FIRE EXTINGUISHERS:	REQUIRED	PROVIDED	

ACCESSIBILITY			
REQUIRED / ALLOWED		PROPOSED	
PARKING SPACES:	EXISTING	EXISTING TO REMAIN	
# OF ACCESSIBLE ROUTES REQUIRED	EXISTING	EXISTING TO REMAIN	
ELEVATORS:	EXISTING	EXISTING TO REMAIN	
STAIRS:	1 EXISTING	1 ETR, ONE NEW PROVIDED	
RAMP:	1 EXISTING	EXISTING TO REMAIN	
SIGNAGE:	REQUIRED	PROVIDED	

PLUMBING FIXTURES			
REQUIRED / ALLOWED		PROPOSED	
WATER CLOSETS:	BUSINESS = 1/25 OCCUPANTS = 2 REQUIRED	3 PROVIDED	
LAVATORIES:	BUSINESS = 1/40 OCCUPANTS = 2 REQUIRED	3 PROVIDED	
DRINKING FOUNTAINS:	BUSINESS = 1/100 OCCUPANTS = 1 REQUIRED	1 EXISTING TO REMAIN	IBC TABLE 2902.1
JANITOR SINK	BUSINESS = 1 REQUIRED	1 PROVIDED	
SHOWERS	BUSINESS = 0 REQUIRED	2 PROVIDED	

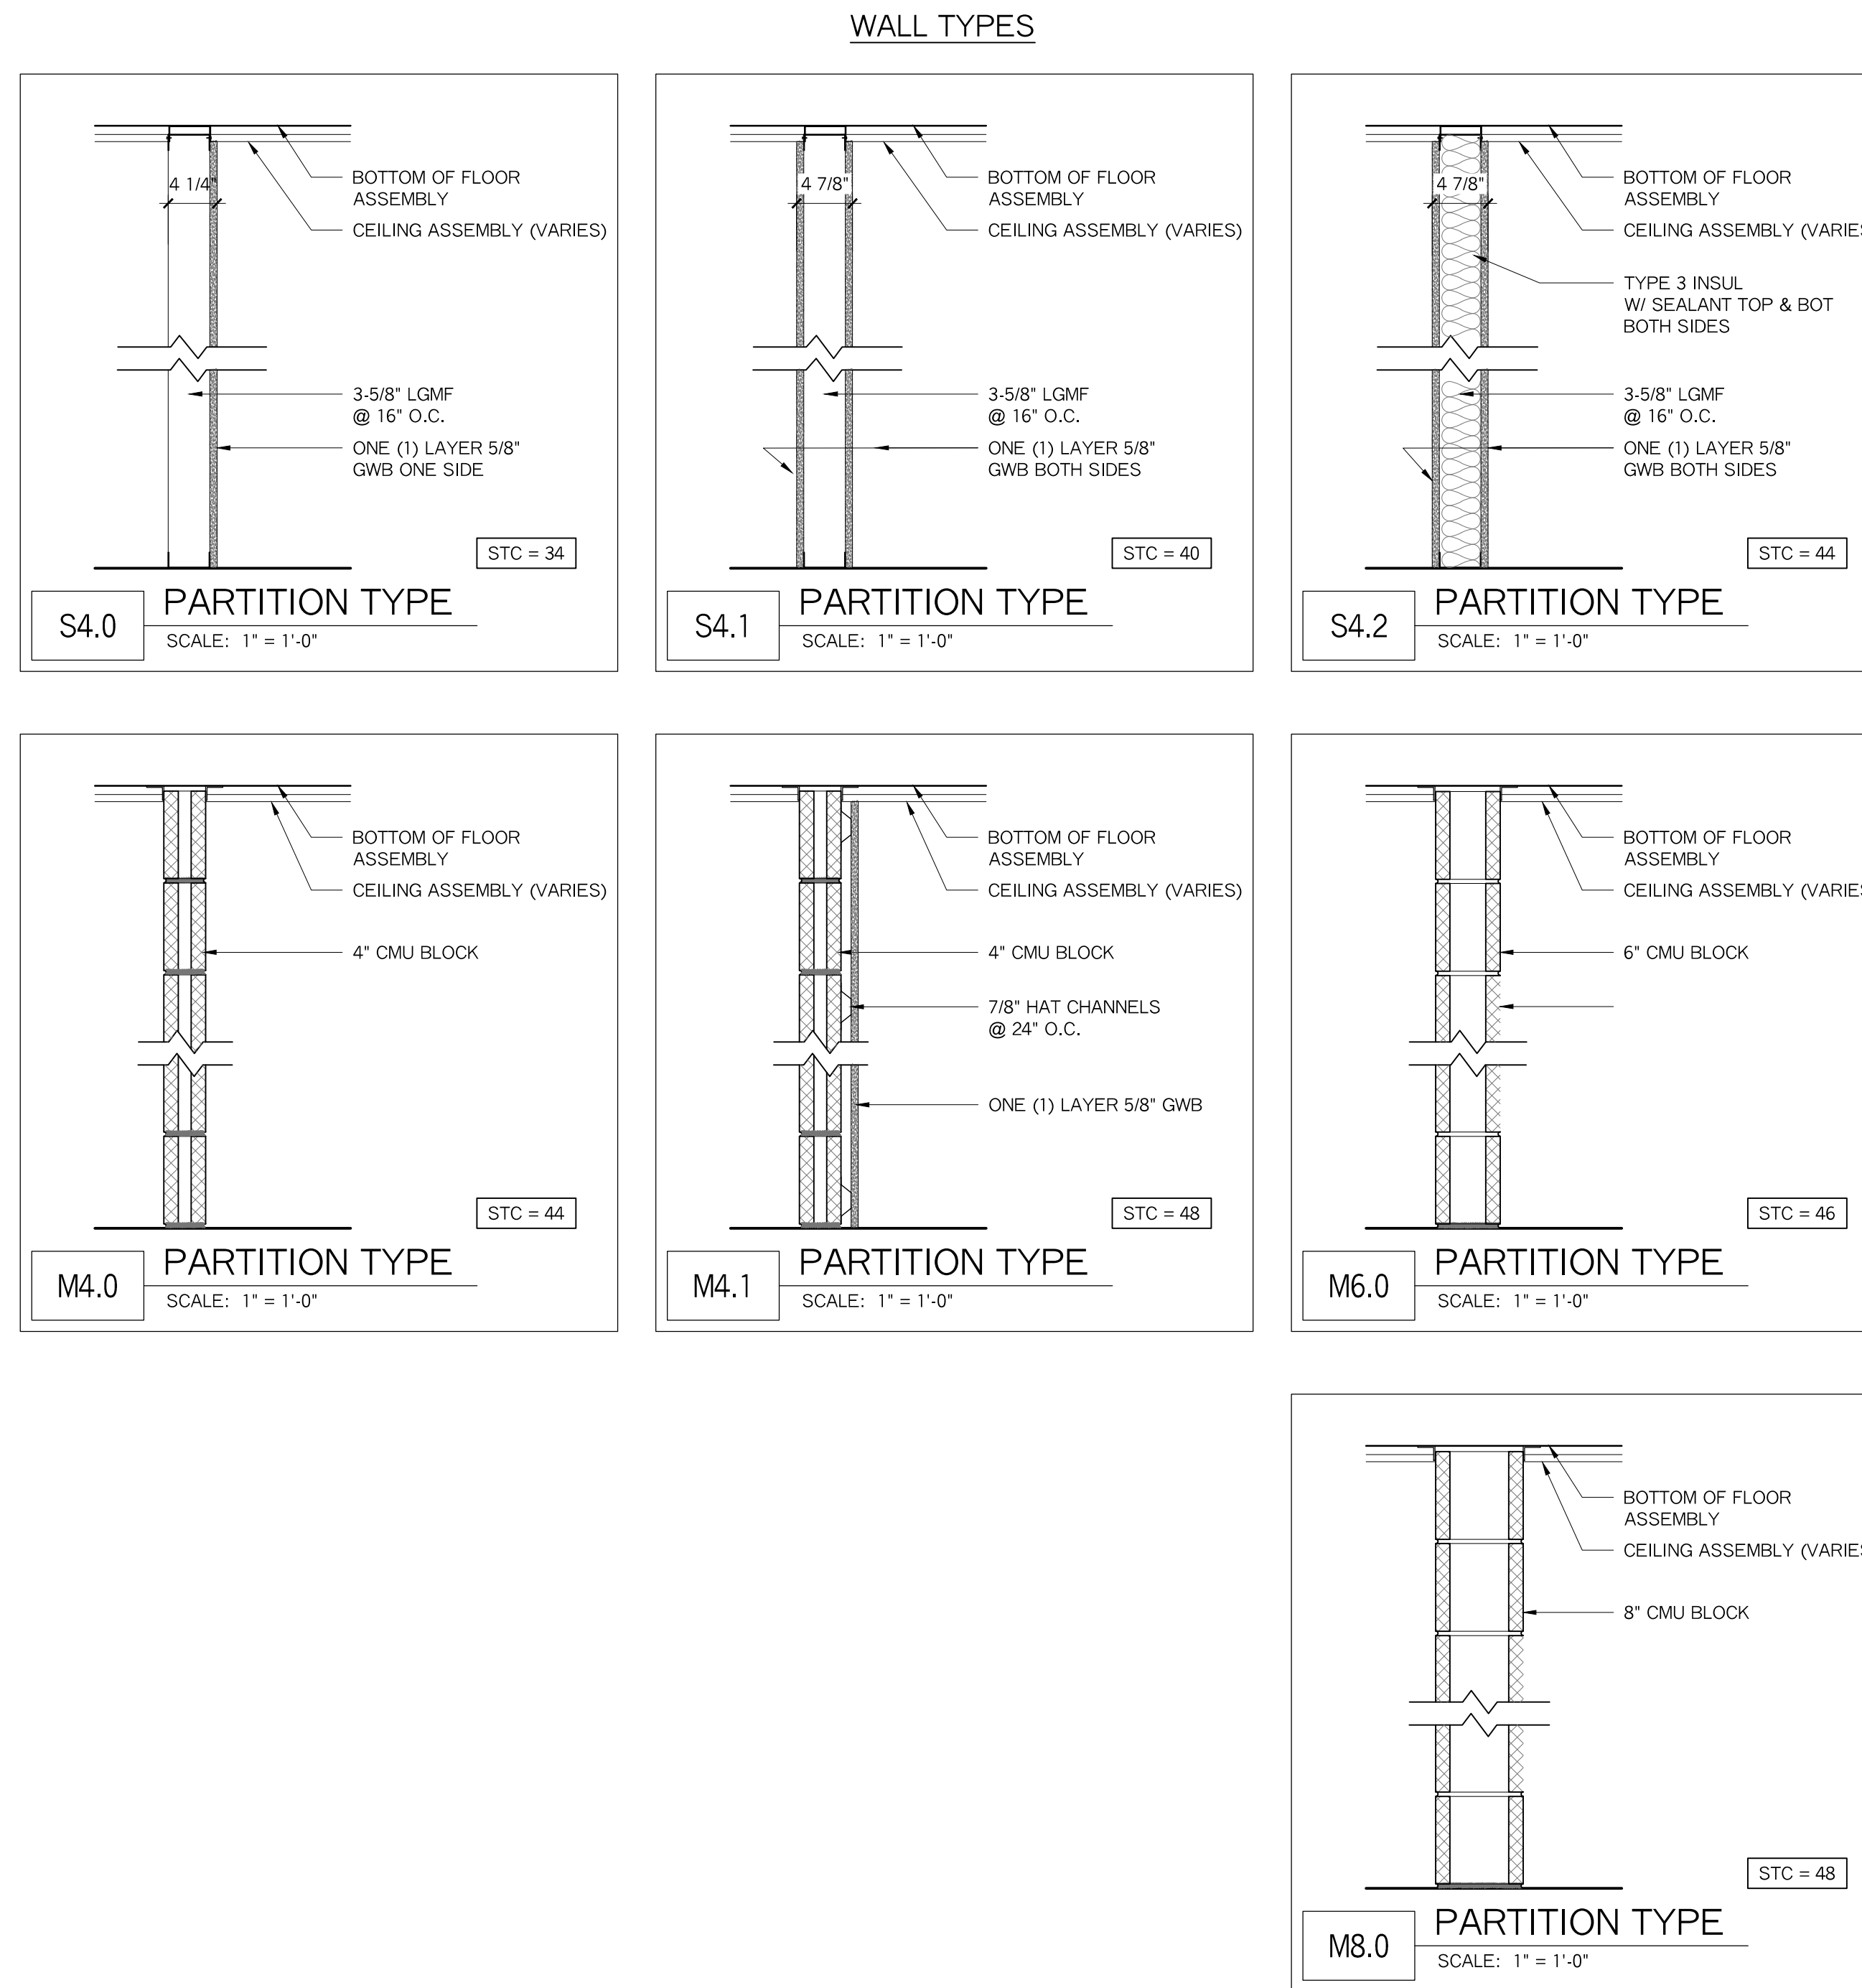

PARTITION NOTES

- SEE STRUCTURAL DRAWINGS FOR FRAMING AND SHEATHING SIZE AND INSTALLATION REQUIREMENTS.
- ALL RATED WALLS & SMOKE BARRIERS TO EXTEND TO HORIZONTAL GWB ASSEMBLY OR ROOF DECK ABOVE. SEAL ALL PENETRATIONS, DECK FLUTES, ETC. AS REQ.; FIRESTOP @ RATED WALLS, FOAM INSUL. @ OTHERS.
- ALL RATED WALLS SHALL BE EFFECTIVELY & PERMANENTLY IDENTIFIED BY STENCILING THE FOLLOWING: "FIRE and/or SMOKE BARRIER - PROTECT ALL OPENINGS" LETTERING SHALL BE 2" HIGH & STATEMENT SHALL OCCUR 30'-0" ALONG WALL. LETTERING SHALL BE PLACED @ TOP OF WALL ABOVE CEILINGS OR IN ATTIC SERVICE AREAS.
- ALL ELECTRICAL LOCATED IN EXTERIOR ICF WALLS TO BE CUT w/ A HOT KNIFE TO CREATE A CHASE, TYP. (SEE ELECTRICAL DRAWINGS.)
- ALL REST ROOMS, SOUND & OFFICE PARTITIONS TO EXTEND TO DECK ABOVE; SEAL ALL PENETRATIONS, TYP.
- AT REST ROOMS & BEHIND COUNTERS W/ SINKS, PROVIDE M.R. GWB IN LIEU OF GWB INDICATED ON PARTITION TYPE.
- PROVIDE GWB CONTROL JOINTS, SPACED AS PER SPECIFICATIONS. VERIFY LOCATIONS w/ ARCHITECT IN FIELD.
- PROVIDE BLOCKING AS REQ'D @ COUNTERS, SHELVES, BATHROOM FIXTURES, DISPLAY BOARDS, ETC. TYP.
- SEE STRUCTURAL DRAWINGS FOR SHEAR WALL LOCATIONS & REQUIREMENTS, TYP. ADDITION OF WOOD STRUCTURAL PANELS TO RATED WALL ASSEMBLY PERMITTED PER ANSIIUL263 Section V1 part 6
- DIMENSIONS ARE FROM FACE OF STUD, OR FACE OF INSULATION ON ICF MASONRY WALL.
- ALL WOOD IN CONTACT W/ CONCRETE SHALL BE PRESSURE TREATED, TYP.


INSULATION TYPES

- TYPE 1: RIGID BOARD INSULATION FOR BELOW GRADE LOCATIONS
 A. XPS INSULATION, TONGUE AND GROOVE EDGES
 B. MIN PSI = 25
 C. MIN R-VALUE = 5 PER INCH
- TYPE 2: LOOSE FILL CELLULOSE INSULATION
 A. DRY BLOWN LOOSE FILL INSULATION IN ATTICS
 B. MIN R-VALUE = 3.8 PER INCH / R60 TOTAL SETTLED DEPTH
- TYPE 3: FIBERGLASS BATT INSULATION
 A. MIN R-VALUE AND THICKNESS AS INDICATED ON DRAWINGS
- TYPE 4: SPRAY FOAM
 A. CLOSED CELL POLYURETHANE TYPE FOAM; 2.0 LB DENSITY
 B. ZERO OZONE DEPLETING AGENTS IN FOAM OR IN BLOWING AGENT
 C. MIN R-VALUE = 7.3 PER INCH (AGED)
- TYPE 5: ACOUSTIC INSULATION
 A. HIGH DENSITY MINERAL FIBER BATT
 B. THICKNESS AS INDICATED ON DRAWINGS
- TYPE 6: WINDOW AND DOOR INSULATION
 A. LOW PRESSURE EXPANDING FOAM
 B. INSTALL WITH EXTREME CARE TO PROTECT DOOR OR WINDOW FRAME FROM DEFORMING, FOLLOW MANUFACTURERS
- INSTRUCTIONS
 TYPE 7: HIGH-DENSITY STRUCTURAL RIGID CELLULAR POLYURETHANE INSULATION
 A. 2 INCH 350 PSI
 TYPE 8: NU-WOOL WALL SEAL



OWNER: WJ Engineering Assoc., PA
 1000 Main Street
 Dover, NH 03820
 www.wjeng.com

PHONE: 603.228.8880
 WWW.SHEER.COM

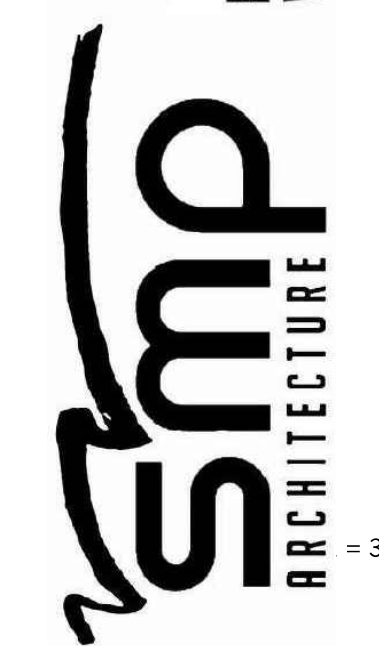

PROJECT: BELKNAP COUNTY SUPERIOR COURT
 64 Court St # 5, Laconia, NH 03246
 Interior Renovations
 CODE REVIEW, ASSEMBLY TYPES & NOTES

REVISION	DATE

SHEET NUMBER: **A002**

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Construction




GENERAL DEMOLITION NOTES

1. OWNER WILL OCCUPY THE BUILDING FOR THE DURATION OF THE PROJECT; CONTRACTOR SHALL PHASE AND SEPARATE THE WORK TO MEET OWNERS OPERATIONAL AND SAFETY REQUIREMENTS.
2. CONTRACTOR SHALL PROVIDE MEANS TO MAINTAIN NEGATIVE PRESSURE IN OCCUPIED BUILDING @ ALL TIMES.
3. THE CONTRACTOR SHALL BE RESPONSIBLE FOR VERIFYING ALL EXISTING CONDITIONS IN THE FIELD PRIOR TO ANY DEMOLITION OR CONSTRUCTION. ANY DISCREPANCIES RELATING TO THE DWG'S SHALL BE REPORTED TO THE ARCHITECT IMMEDIATELY.
4. THE CONTRACTOR SHALL BE AWARE OF SELECTIVE DEMOLITION @ ALL SECTIONS OF WORK, REVIEWING ALL NEW & RENOVATION DETAILS TO DETERMINE WHAT IS TO BE REMOVED OR TO REMAIN & WILL BE RESPONSIBLE FOR REPLACEMENT IN-KIND ALL WORK INADVERTENTLY REMOVED.
5. THE CONTRACTOR SHALL REMOVE ITEMS TO BE DEMOLISHED AS INDICATED ON THE DWG'S W/ CARE BEING TAKEN NOT TO DAMAGE ADJACENT WALLS, CEILINGS, FLOORS, FINISHES, CASEWORK OR MILLWORK SCHEDULED TO REMAIN. THE WORK AREA WILL BE LEFT CLEAN & READY TO RECEIVE NEW WORK.
6. CONTRACTOR SHALL COORDINATE DEMOLITION REQUIREMENTS WITH THAT OF NEW WORK AND EQUIPMENT TO ENSURE NEW EQUIPMENT CAN BE MOVED INTO INTENDED FINAL POSITION. ITEM NOT INDICATED SPECIFICALLY INDICATED ON THE DEMOLITION DRAWINGS, BUT REQUIRED FOR INSTALLATION OF NEW WORK SHALL BE THE RESPONSIBILITY OF THE CONTRACTOR.
7. CONTRACTOR SHALL BE RESPONSIBLE FOR REMOVING, RECYCLING & LEGALLY DISPOSING OF ALL MATERIALS.
8. PATCH & REPAIR ALL EXISTING-TO-REMAIN WALLS, FLOORING, & CEILINGS DAMAGED DURING DEMOLITION OR REMOVAL OF EXISTING CONSTRUCTION. REFER TO ARCHITECTURAL DRAWINGS FOR OTHER AREAS OF PATCHING, REPAIR & INFILL.
9. PROVIDE ROUGH OPENINGS AS REQ'D FOR NEW MECHANICAL, ELECTRICAL, OR PLUMBING - COORDINATE W/ M, E, & P DWG'S.
10. SEE MECHANICAL, PLUMBING & ELECTRICAL DWG'S FOR ADDITIONAL DEMO INFORMATION.
11. EXISTING EQUIPMENT DESIGNATED TO BE RE-USED SHALL BE CAREFULLY REMOVED, ADEQUATELY STORED, & RE-INSTALLED ACCORDING TO DWG'S. COORDINATE ANY TEMPORARY CAPPING OF WATER & UTILITY LINES AS REQ'D.

DEMOLITION PLAN KEY NOTES:

- 1 REMOVE PORTION OF EXISTING FLOOR ASSEMBLY. COORDINATE W/ RESPECTIVE DRAWINGS FOR INTENDED FINISHED RESULT.
- 2 REMOVE STUD WALL ASSEMBLY, OR PORTION THEREOF.
- 3 REMOVE MASONRY OR CONCRETE WALL ASSEMBLY, OR PORTION THEREOF.
- 4 REMOVE FLOOR FINISH, PAD, TRANSITION STRIPS & MASTIC DOWN TO FINISHED SURFACE. LEAVE SURFACE SMOOTH, CLEAN & READY TO RECEIVE NEW FINISH.
- 5 REMOVE WINDOW ASSEMBLY BACK TO ROUGH OPENING
- 6 REMOVE DOOR AND FRAME ASSEMBLY BACK TO ROUGH OPENING
- 7 REMOVE CEILING FINISH AND ASSOCIATED FRAMING SYSTEM (IF HUNG CEILING TYPE); REMOVE ALL ASSOCIATED LIGHTING, DIFFUSERS AND DEVICES.
- 8 REMOVE ALL TOILET ACCESSORIES AND PARTITIONS
- 9 REMOVE PLUMBING FIXTURES, SHUT OFF, DISCONNECT AND CAP ALL ASSOCIATED PIPING
- 10 REMOVE MECHANICAL EQUIPMENT, SHUT OFF, DISCONNECT AND CAP ALL ASSOCIATED PIPING, DUCTWORK, ETC.
- 11 REMOVE ELECTRICAL FIXTURES, SHUT OFF, DISCONNECT AND CAP ALL ASSOCIATED WIRING

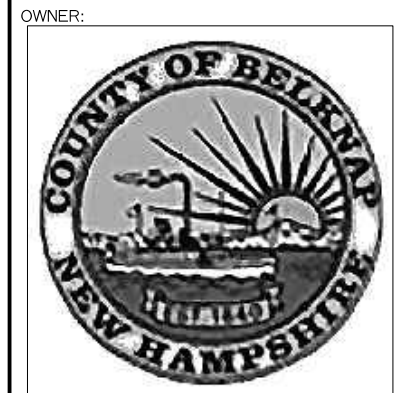

OWNER: WJ Engineering Assoc. PA
 11 High Street
 Laconia, NH 03246
 Phone: 603.921.1017

PHONE: 603.228.8880
WWW.SHEER.COM

BELKNAP COUNTY SUPERIOR COURT
 64 Court St # 5, Laconia, NH 03246

Interior Renovations

BASEMENT LEVEL DEMOLITION PLAN


PROJECT:	BELKNAP COUNTY SUPERIOR COURT
ISSUED:	DESIGN DEVELOPMENT
JOB NO:	23-011
DRAWN BY:	V.A.D.
CHECKED BY:	A.M.
DATE:	OCTOBER 09, 2023
REVISION	DATE

SHEET NUMBER: **AD100**

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GENERAL DEMOLITION NOTES

1. OWNER WILL OCCUPY THE BUILDING FOR THE DURATION OF THE PROJECT; CONTRACTOR SHALL PHASE AND SEPARATE THE WORK TO MEET OWNERS OPERATIONAL AND SAFETY REQUIREMENTS.
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4. THE CONTRACTOR SHALL BE AWARE OF SELECTIVE DEMOLITION @ ALL SECTIONS OF WORK, REVIEWING ALL NEW & RENOVATION DETAILS TO DETERMINE WHAT IS TO BE REMOVED OR TO REMAIN & WILL BE RESPONSIBLE FOR REPLACEMENT IN- KIND ALL WORK INADVERTENTLY REMOVED.
5. THE CONTRACTOR SHALL REMOVE ITEMS TO BE DEMOLISHED AS INDICATED ON THE DWG'S W/ CARE BEING TAKEN NOT TO DAMAGE ADJACENT WALLS, CEILINGS, FLOORS, FINISHES, CASEWORK OR MILLWORK SCHEDULED TO REMAIN. THE WORK AREA WILL BE LEFT CLEAN & READY TO RECEIVE NEW WORK.
6. CONTRACTOR SHALL COORDINATE DEMOLITION REQUIREMENTS WITH THAT OF NEW WORK AND EQUIPMENT TO ENSURE NEW EQUIPMENT CAN BE MOVED INTO INTENDED FINAL POSITION. ITEM NOT INDICATED SPECIFICALLY INDICATED ON THE DEMOLITION DRAWINGS, BUT REQUIRED FOR INSTALLATION OF NEW WORK SHALL BE THE RESPONSIBILITY OF THE CONTRACTOR.
7. CONTRACTOR SHALL BE RESPONSIBLE FOR REMOVING, RECYCLING & LEGALLY DISPOSING OF ALL MATERIALS.
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10. SEE MECHANICAL, PLUMBING & ELECTRICAL DWG'S FOR ADDITIONAL DEMO INFORMATION.
11. EXISTING EQUIPMENT DESIGNATED TO BE RE-USED SHALL BE CAREFULLY REMOVED, ADEQUATELY STORED, & RE-INSTALLED ACCORDING TO DWG'S. COORDINATE ANY TEMPORARY CAPPING OF WATER & UTILITY LINES AS REQ'D.

DEMOLITION PLAN KEY NOTES:
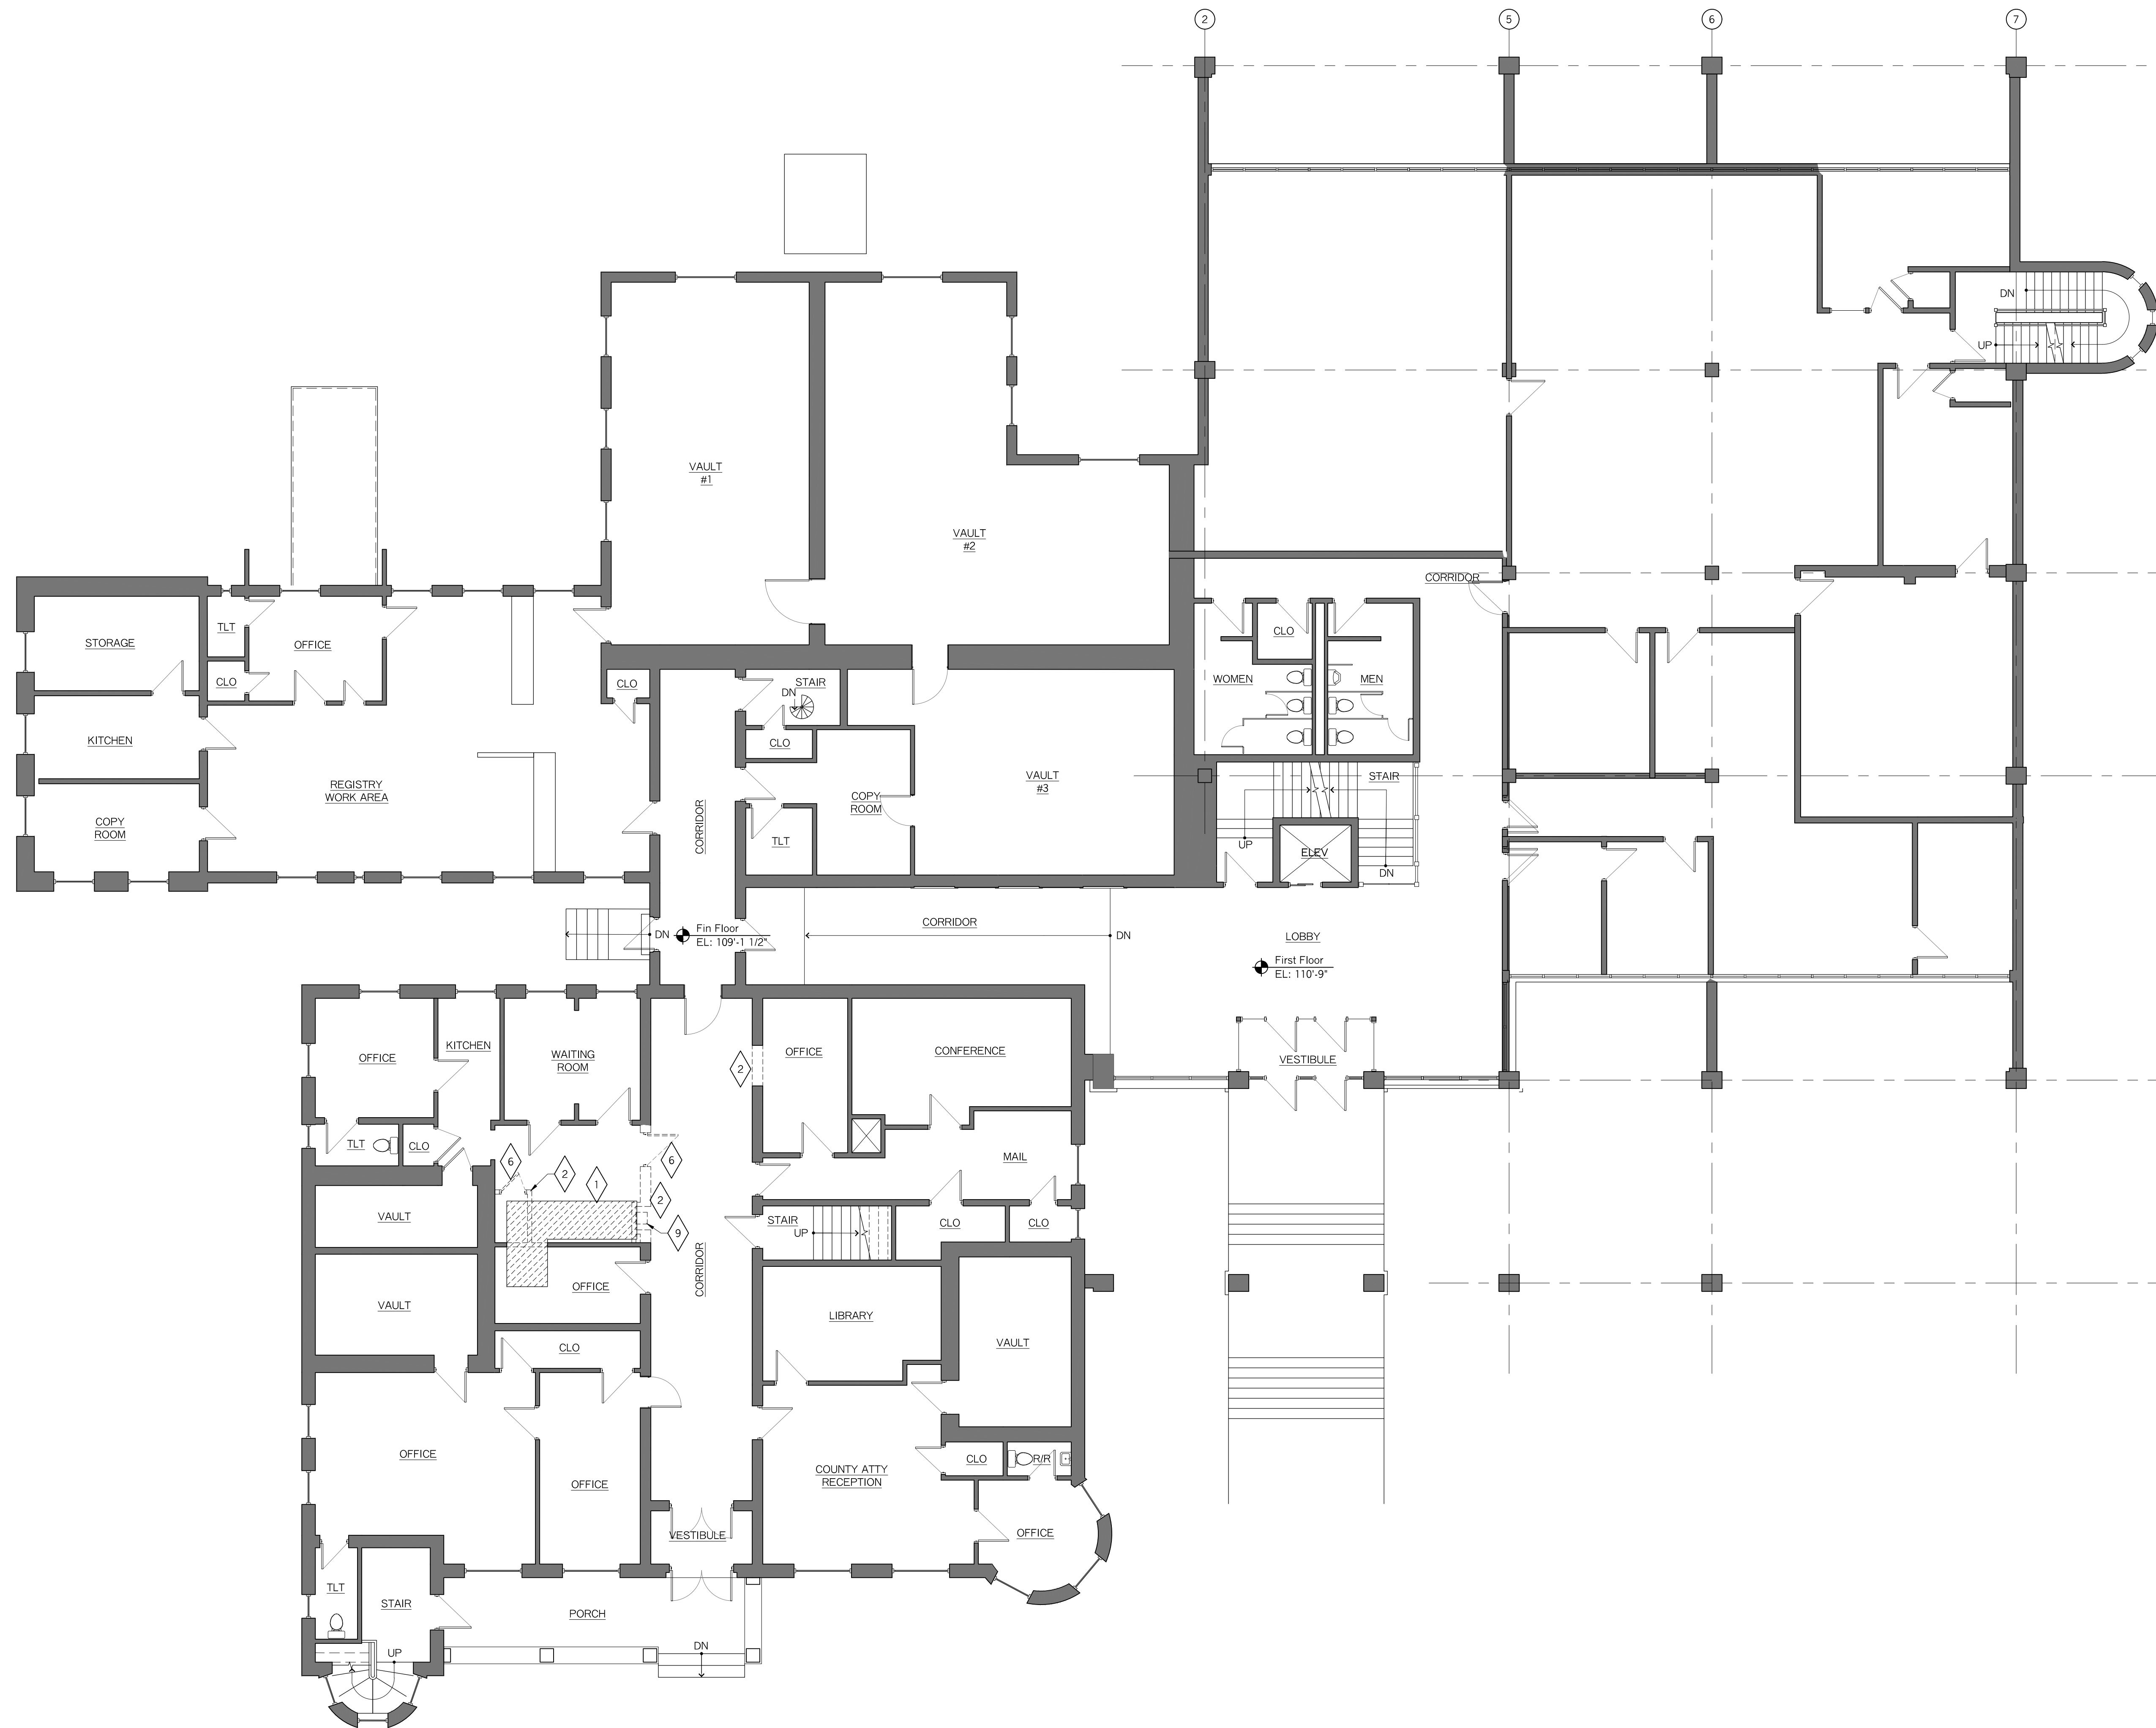
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- 9 REMOVE PLUMBING FIXTURES, SHUT OFF, DISCONNECT AND CAP ALL ASSOCIATED PIPING
- 10 REMOVE MECHANICAL EQUIPMENT, SHUT OFF, DISCONNECT AND CAP ALL ASSOCIATED PIPING, DUCTWORK, ETC.
- 11 REMOVE ELECTRICAL FIXTURES, SHUT OFF, DISCONNECT AND CAP ALL ASSOCIATED WIRING



OWNER: W/ Engineering Assoc. PA
11 Elm Street
Laconia, NH 03246
Phone: 603.228.8880

PHONE: 603.228.8880
WWW.SHEER.COM

PROJECT: BELKNAP COUNTY SUPERIOR COURT
64 Court St # 5, Laconia, NH 03246

DRAWING TITLE: Interior Renovations
FIRST FLOOR DEMOLITION PLAN


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DATE:	OCTOBER 09, 2023
REVISION	DATE

SHEET NUMBER: **AD101**

1 FIRST FLOOR DEMOLITION PLAN
1/8" = 1'-0"



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GENERAL NOTES

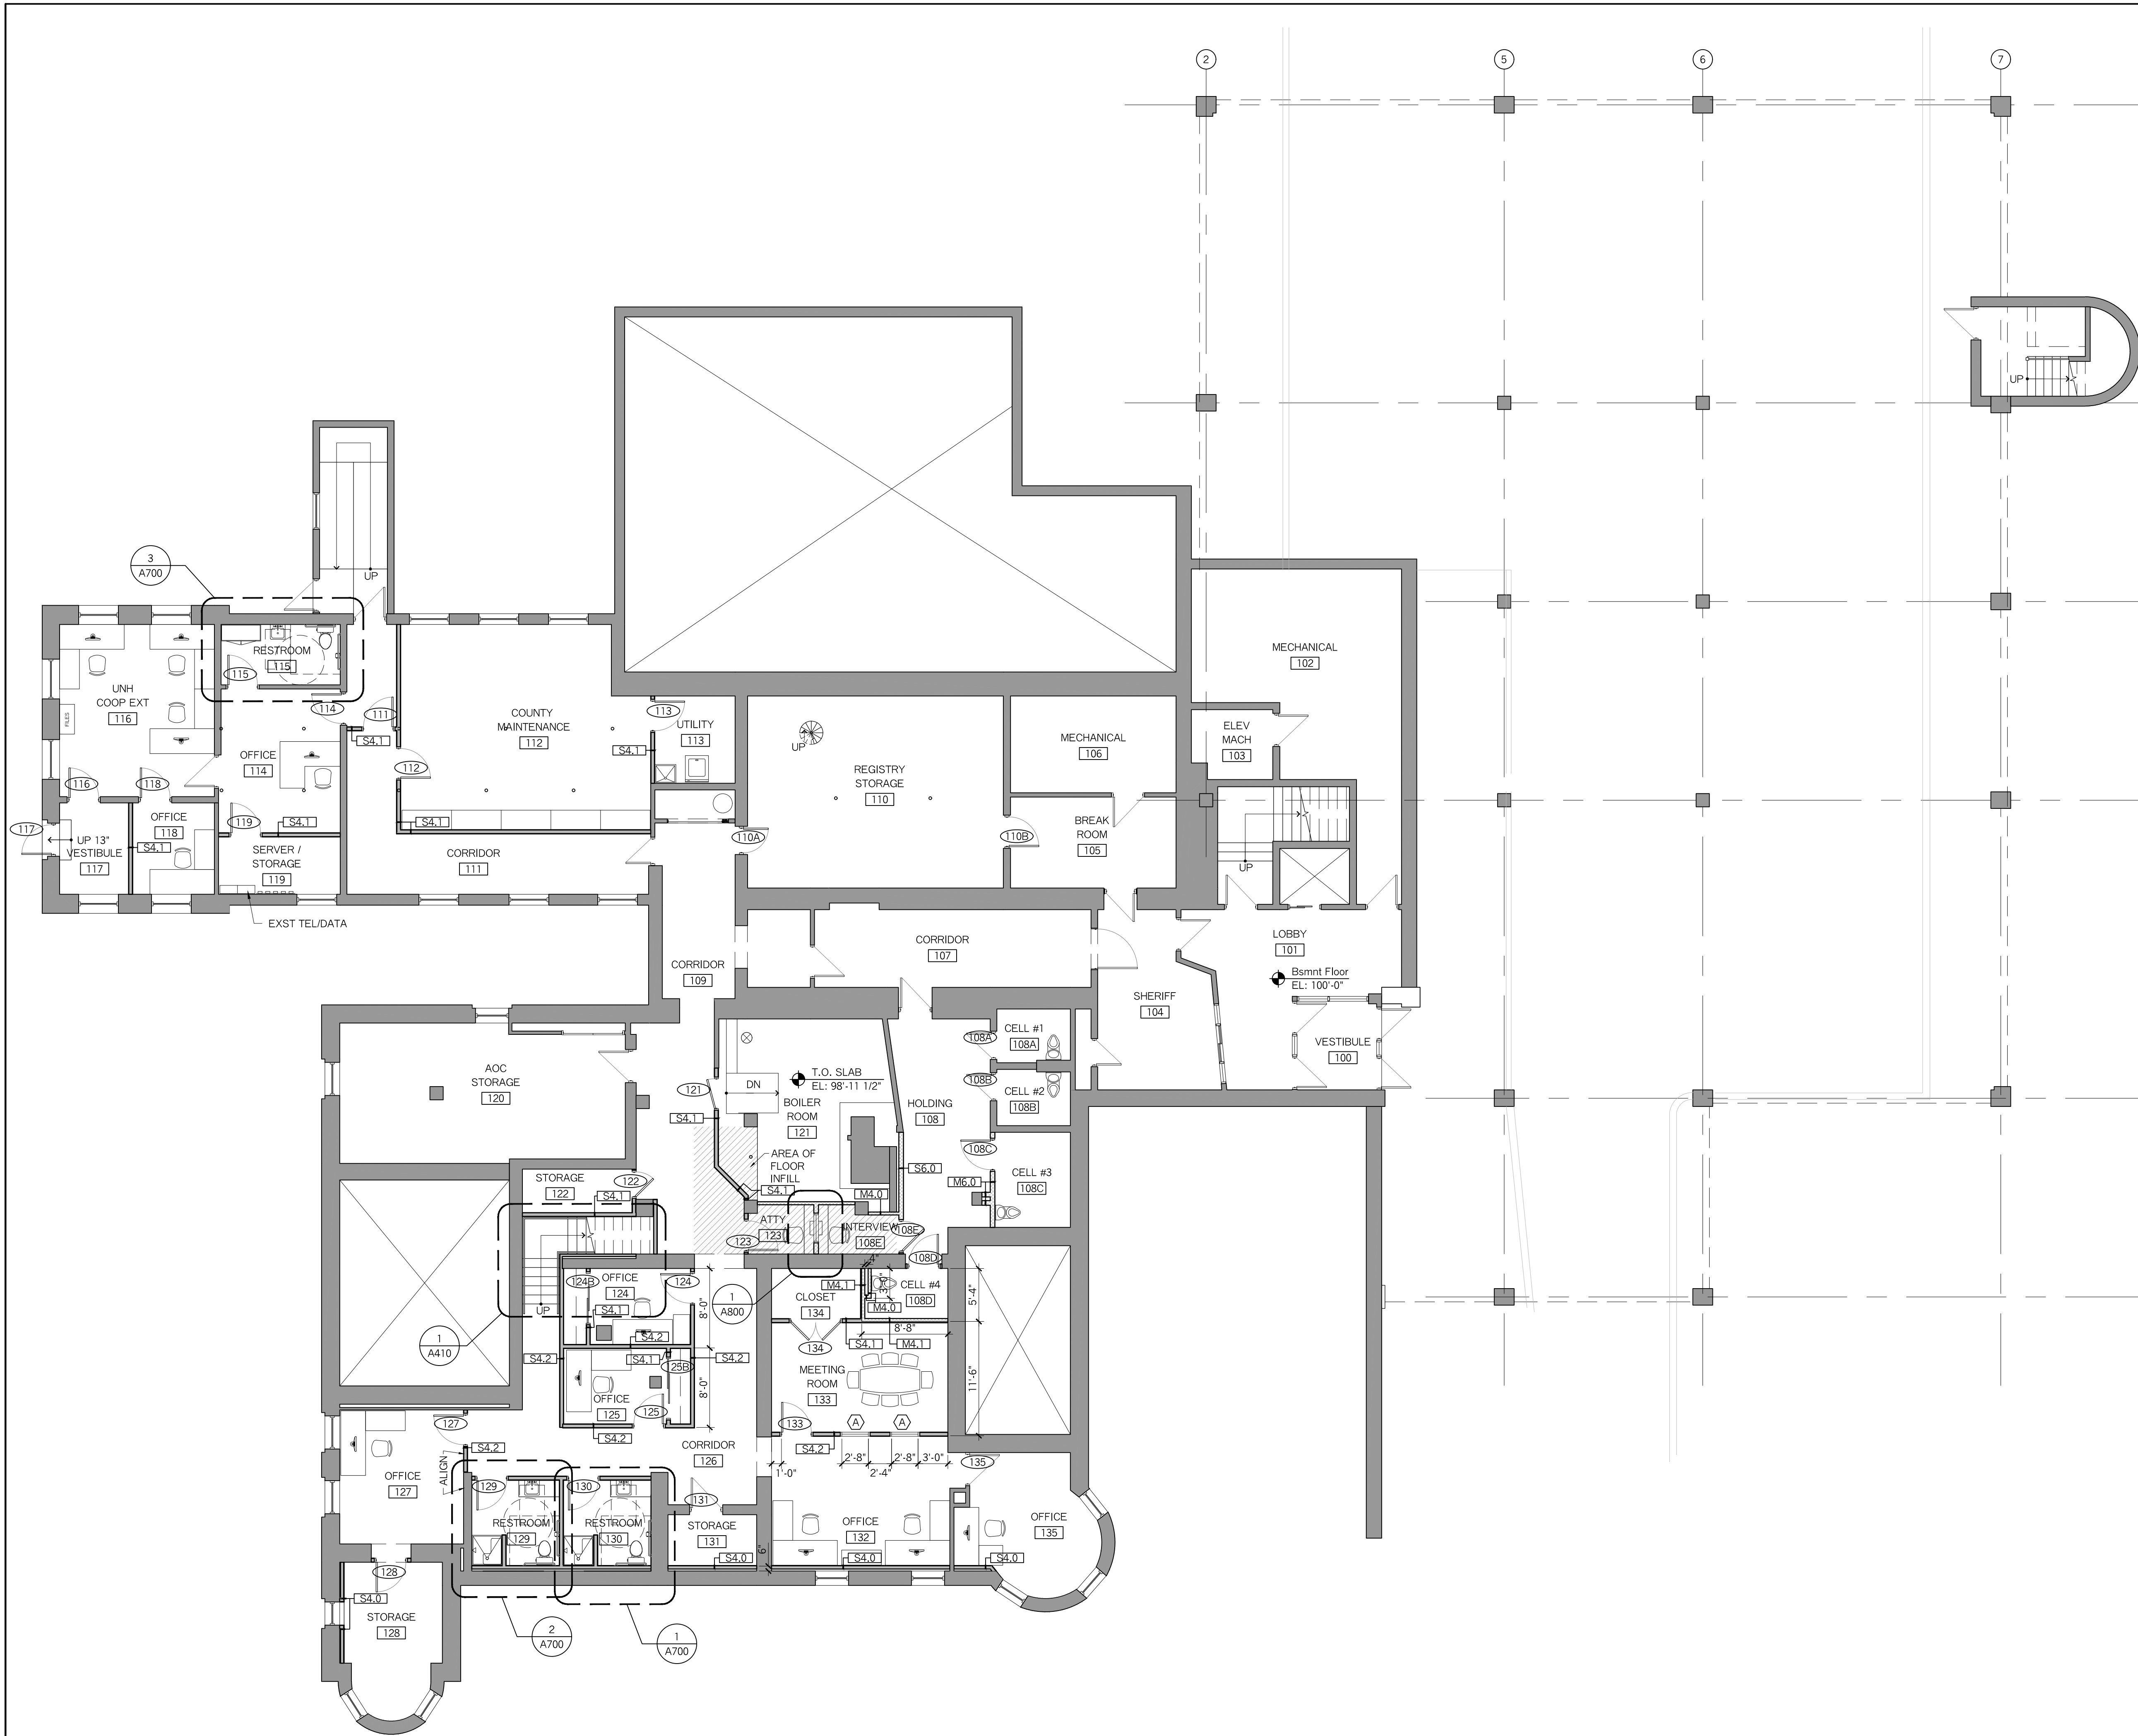1. REFERENCE ELEVATION = 100'-0"
2. SEE CIVIL PLANS FOR SITE INFORMATION.
3. SEE STRUCTURAL PLANS FOR STRUCTURAL DETAILS, LINTEL SIZES & NOTES.
4. SEE MECHANICAL DRAWINGS FOR DUCT SIZES.
5. SEE A002 FOR WALL TYPES.
6. ALL DIMENSIONS ARE GIVEN TO FACE OF EXISTING WALL FINISH, FACE OF STUDS, FACE OF MASONRY WALL OR MASONRY OPENING, CENTER OF STRUCT. STEEL
7. ALL DOORS TO BE INSTALLED WITH HINGE SIDE 4" FROM NEAREST INSIDE CORNER, UNLESS OTHERWISE DIMENSIONED.
8. PROVIDE BLOCKING AS REQ. FOR TOILET ACCESSORIES, CABINETS, SHELVES, ETC.
9. PROVIDE FIREBLOCKING/FIRESTOPPING AS REQ. AT PENETRATIONS IN RATED WALLS/CEILING, TYP.
10. PROVIDE LOW PRESSURE SPRAY FOAM INSULATION AROUND ALL DOORS, WINDOWS, ETC., WHERE NECESSARY IN EXTERIOR WALLS TO MEET AIR INFILTRATION REQUIREMENTS, SEE SPECIFICATIONS.
11. PROVIDE SEALANT AS REQUIRED AT TRIM, WINDOWS, ETC., TYP.
12. ALL PAINTS AND ADHESIVES TO BE LOW V.O.C.
13. PATCH TO MATCH EXISTING AS REQUIRED DUE TO NEW WORK.
14. ALL EXTERIOR GRADE MOUNTED MECHANICAL EQUIPMENT TO BE ON CONC. SLAB. SEE MECHANICAL, STRUCTURAL AND CIVIL DRAWINGS.
15. ALL EXTERIOR CONC. PADS SHALL PITCH AWAY FROM BUILDING 1/4" PER FT., UNLESS OTHERWISE NOTED.
16. NOTIFY ARCHITECT IMMEDIATELY REGARDING ANY QUESTIONS / CLARIFICATIONS REGARDING NOTATIONS, DETAILS, ETC. PRIOR TO INSTALLATION.



OWNER: County of Belknap
 NEW HAMPSHIRE

MEP ENGINEER: WJ Engineering Assoc. PA
 11 Park Drive
 Laconia, NH 03246
 Phone: 603-531-1517

PHONE: 603.228.8880
 WWW.SHEER.COM



PROJECT: BELKNAP COUNTY SUPERIOR COURT
 64 Court St # 5, Laconia, NH 03246
 Interior Renovations
 FIRST FLOOR PLAN

DRAWING TITLE: Interior Renovations


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1 BASEMENT LEVEL FLOOR PLAN
 1/8" = 1'-0"



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GENERAL NOTES

1. REFERENCE ELEVATION = 100'-0"
2. SEE CIVIL PLANS FOR SITE INFORMATION.
3. SEE STRUCTURAL PLANS FOR STRUCTURAL DETAILS, LINTEL SIZES & NOTES.
4. SEE MECHANICAL DRAWINGS FOR DUCT SIZES.
5. SEE A002 FOR WALL TYPES.
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10. PROVIDE LOW PRESSURE SPRAY FOAM INSULATION AROUND ALL DOORS, WINDOWS, ETC., WHERE NECESSARY IN EXTERIOR WALLS TO MEET AIR INFILTRATION REQUIREMENTS, SEE SPECIFICATIONS.
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12. ALL PAINTS AND ADHESIVES TO BE LOW V.O.C.
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16. NOTIFY ARCHITECT IMMEDIATELY REGARDING ANY QUESTIONS / CLARIFICATIONS REGARDING NOTATIONS, DETAILS, ETC. PRIOR TO INSTALLATION.

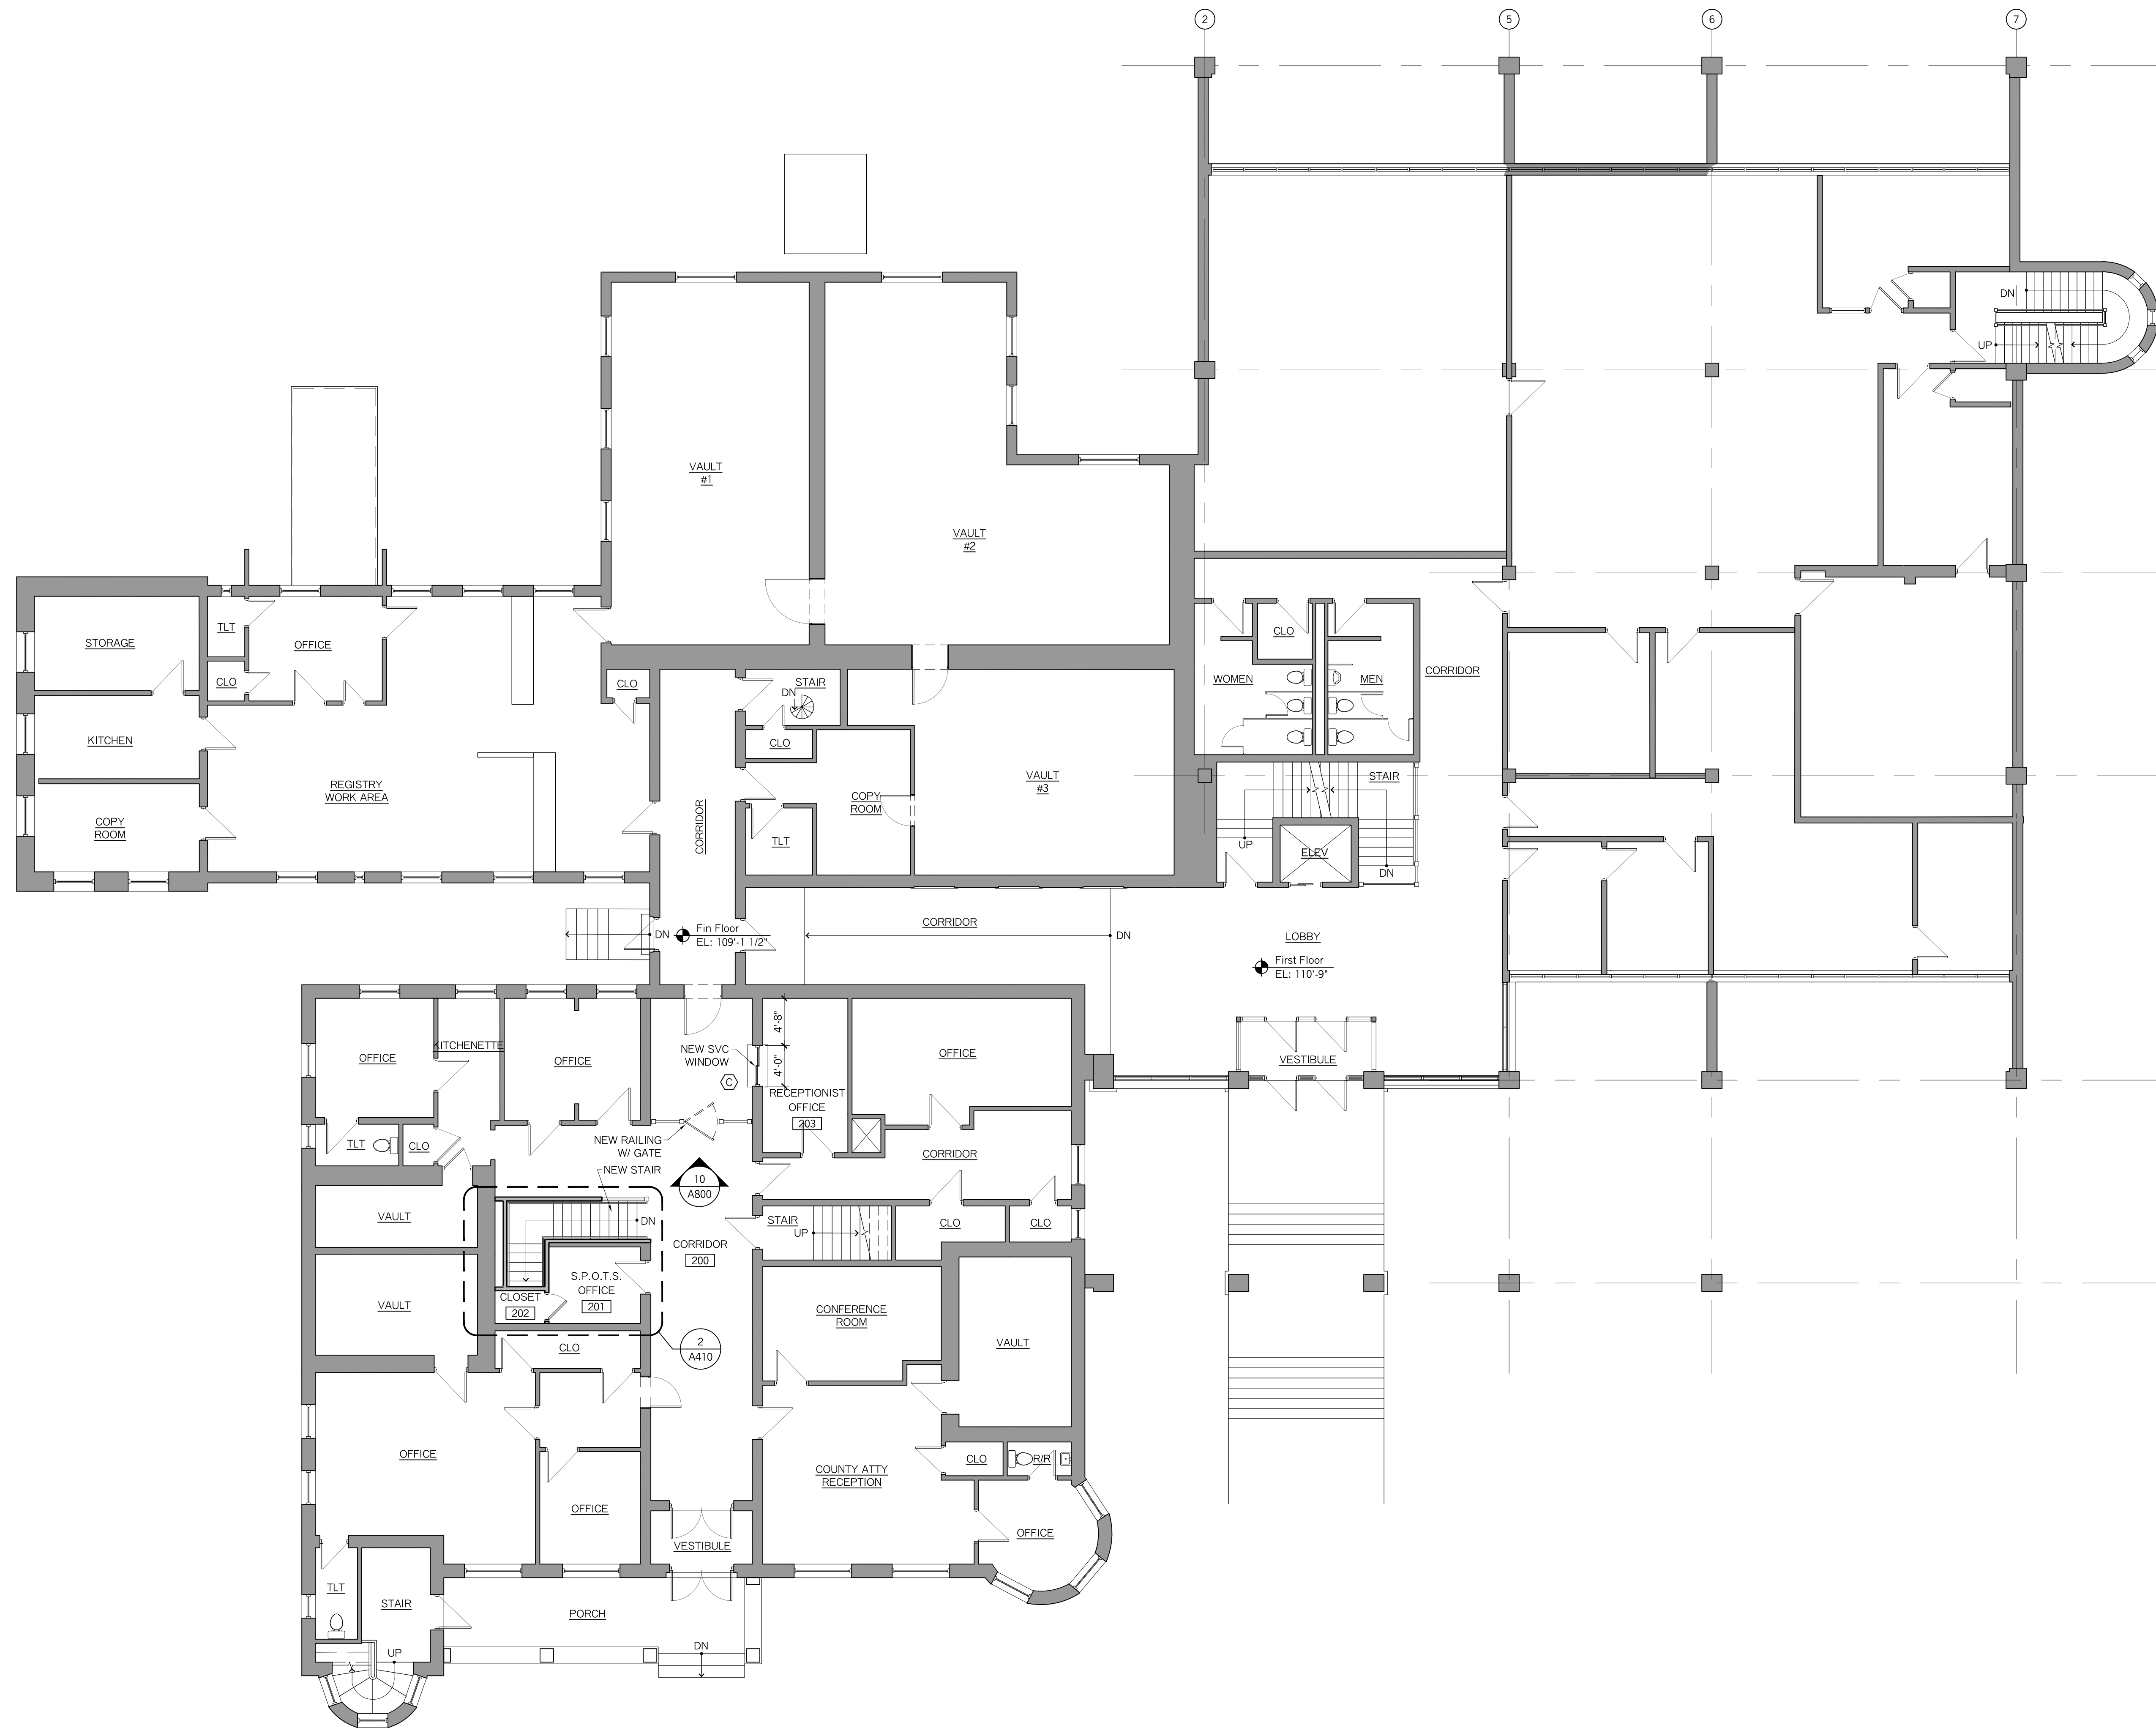

OWNER: WJ Engineering Assoc. PA
 11 High Street
 Laconia, NH 03246
 Phone: 603.228.8880

PHONE: 603.228.8880
 WWW.SHEER.COM



PROJECT: BELKNAP COUNTY SUPERIOR COURT
 64 Court St # 5, Laconia, NH 03246
 Interior Renovations
 FIRST FLOOR PLAN


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1 FIRST FLOOR PLAN
 1/8" = 1'-0"



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1 BASEMENT LEVEL REFLECTED CEILING PLAN
1/8" = 1'-0"

2 PARTIAL FIRST FLOOR REFLECTED CEILING PLAN
1/8" = 1'-0"

GENERAL RCP NOTES

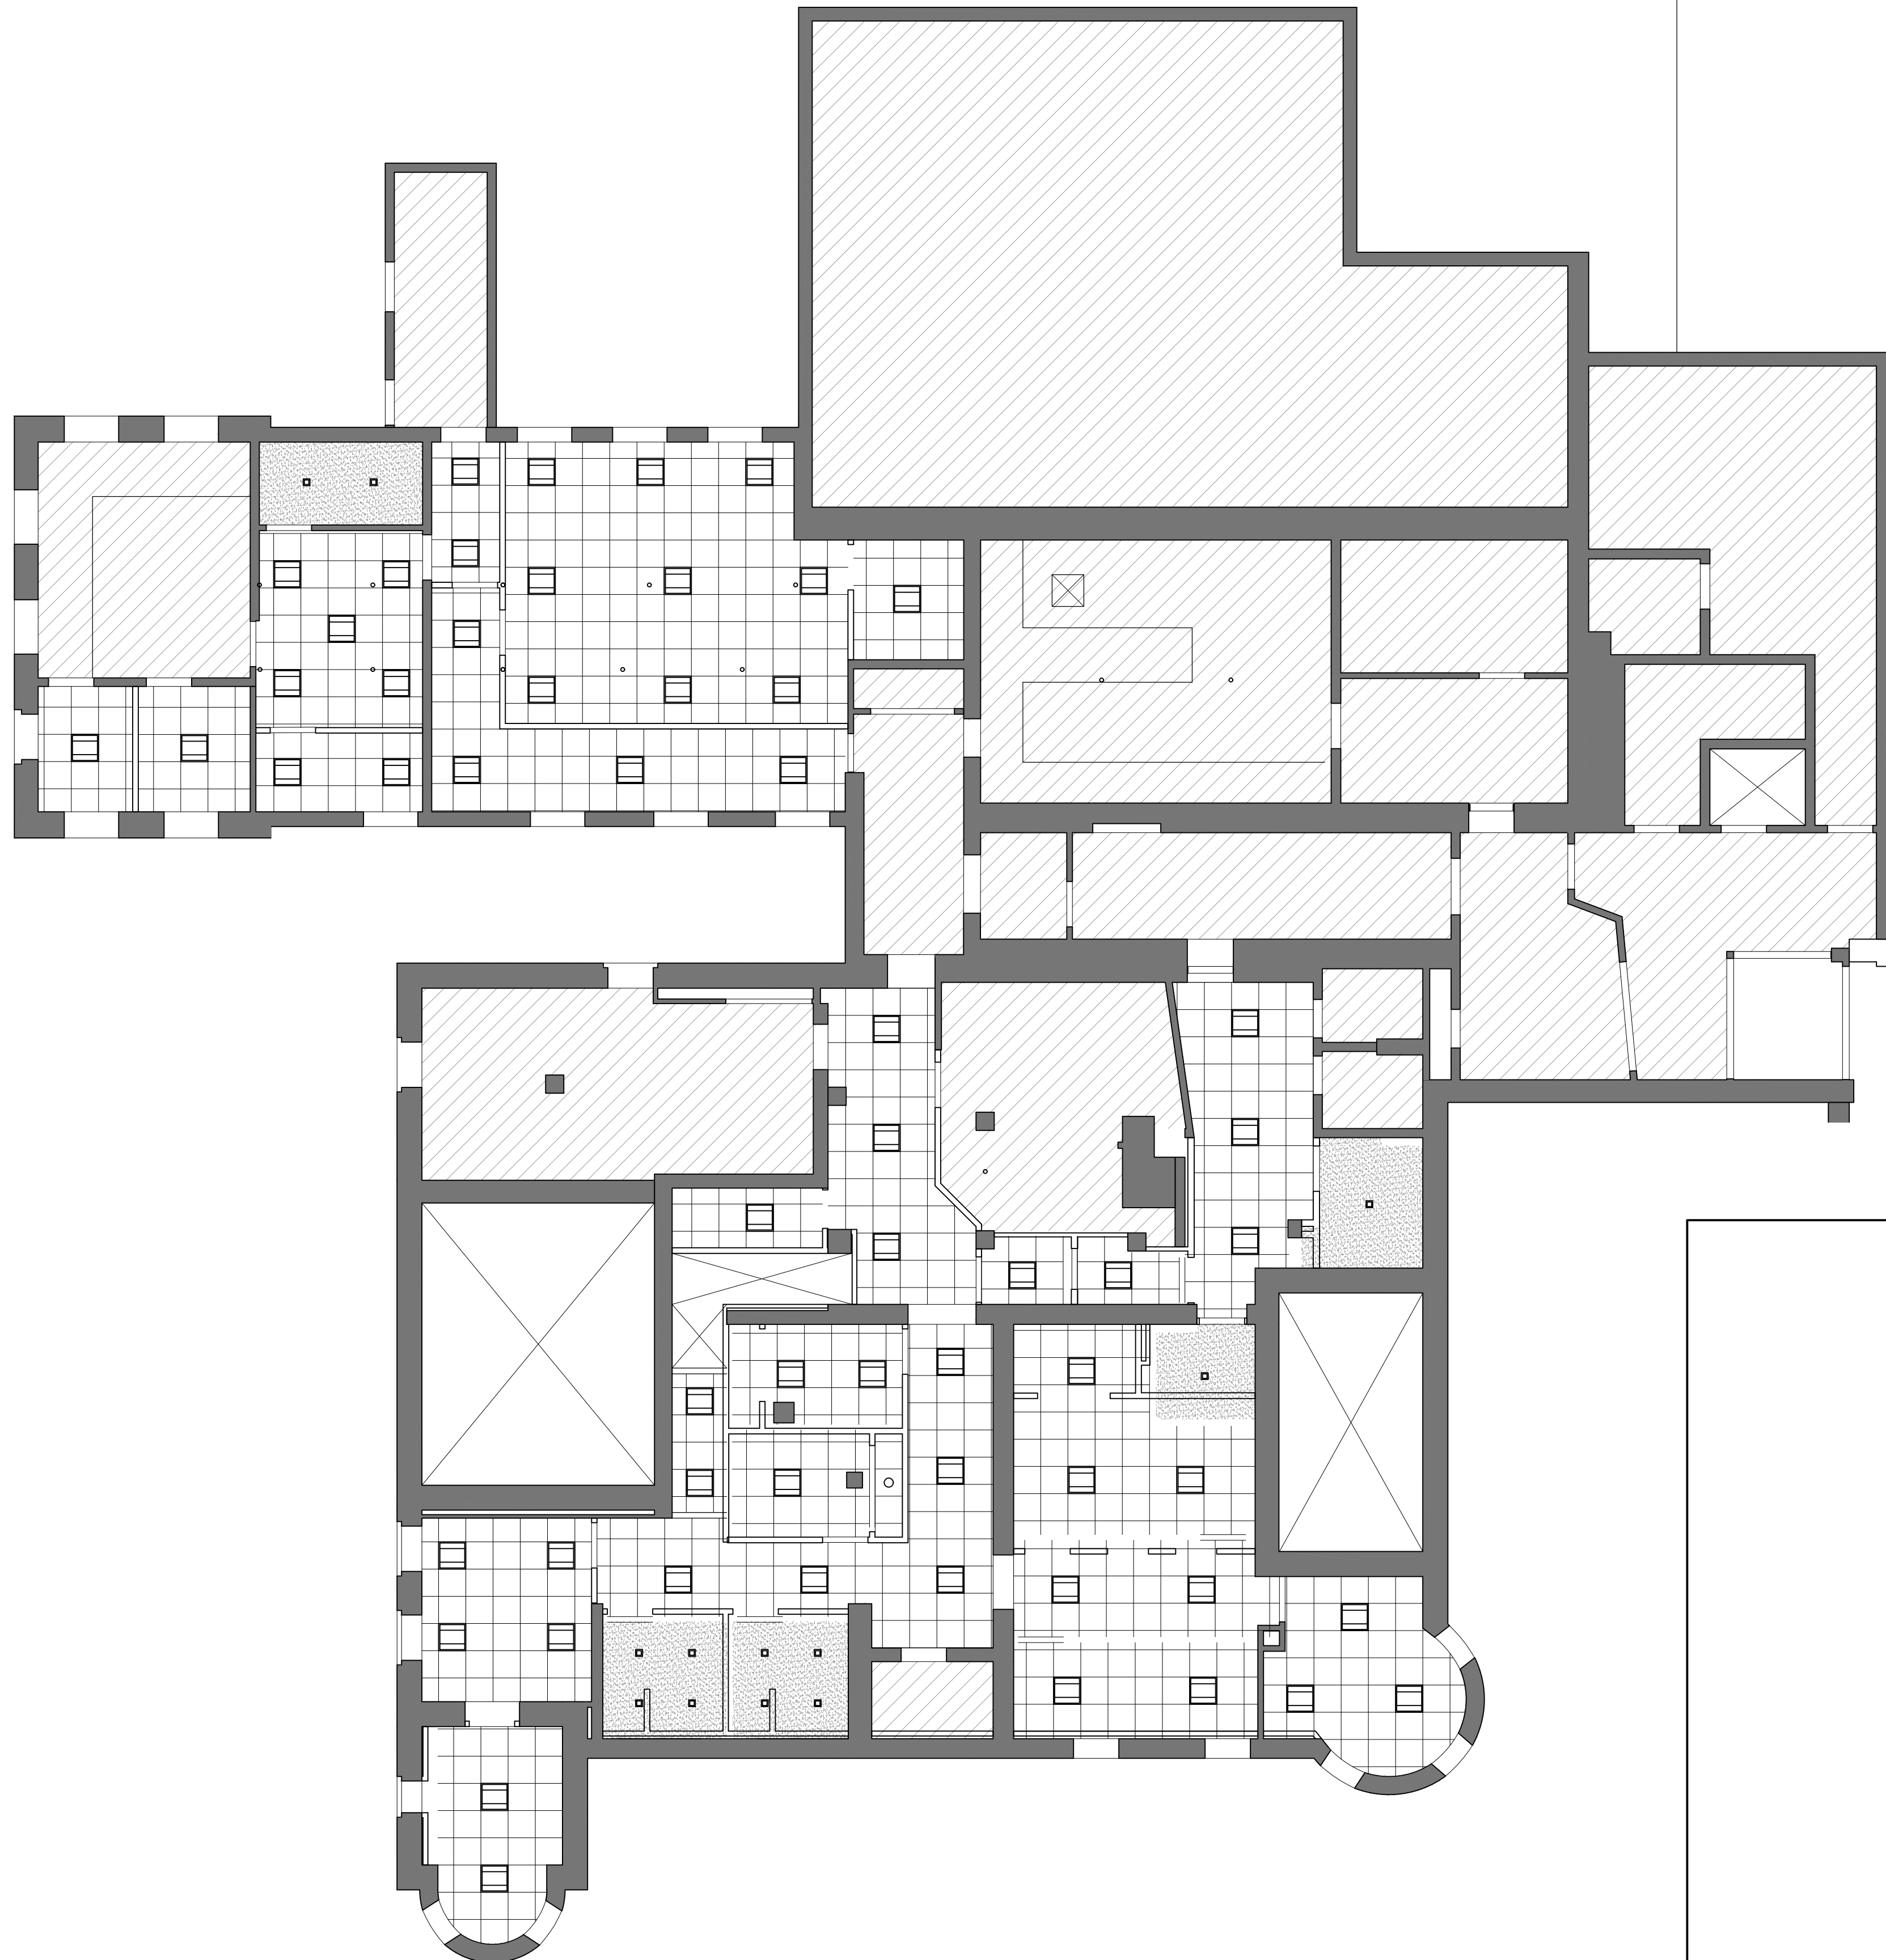1. ALL HEIGHTS FROM FINISH FLOOR IN SPACE UNLESS OTHERWISE NOTED.
2. SEE MECHANICAL DRAWINGS FOR DIFFUSER TYPES AND HVAC LAYOUTS.
3. SEE ELECTRICAL DRAWINGS FOR FIXTURE TYPES AND LIGHTING LAYOUTS.
4. PROVIDE VAPOR BARRIER, 1x FURRING @ 16"OC AND 5/8" TYPE X GWB WITH LEVEL 1 FINISH AT UNDERSIDE OF ROOF TRUSSES ABOVE ALL FINISH CEILINGS.
6. PROVIDE 2 UTILITY LIGHT FIXTURES IN ATTIC SPACE w/ SWITCH AT ACCESS LOCATION.
7. ATTIC HATCH BASED ON: BATTIC DOOR-R50. FIT BETWEEN TRUSSES.
8. CENTER TILE WITHIN ROOM IN ALL LOCATIONS, UNLESS OTHERWISE SHOWN.
9. CENTER ALL SPRINKLER HEADS IN CENTER OF TILE, TYP.

CEILING TYPE LEGEND

- ACOUSTIC CEILING SYSTEMS**
- 1.1 24 x 24, TEGULAR EDGE; ARMSTRONG DUNE WITH 3/16" SUPRAFINE GRID, WHITE
 - 1.2 48 x 72 SOUNDSCAPES BASIC ACOUSTIC PANEL BY ARMSTRONG
 - 1.3 48 x 96 SOUNDSCAPES BASIC ACOUSTIC PANEL BY ARMSTRONG

- GWB SYSTEMS**
- 2.1 5/8" GWB PTD.; ATTACH TO RIGID LIGHT GAUGE METAL FRAMING SYSTEM
 - 2.2 1- HOUR RATED HORIZONTAL SHAFTWALL ASSEMBLY; SIZE I-STUDS FOR SPANS; SYSTEM AS TESTED AND SPECIFIED BY NATIONAL GYPSUM CO.

- MISC.**
- 3.1 PATCH, REPAIR OR RECONSTRUCT EXISTING HARD CEILING FINISH; MATCH EXISTING FINISH TEXTURE; PAINT ENTIRE CEILING
 - 3.2 EXISTING TO REMAIN; PROVIDE NEW PAINT
 - 3.3 1x6 T & G FIR w/ CLEAR OIL FINISH
 - 3.4 EXPOSED STRUCTURE; PROVIDE NEW PAINT FINISH

REFLECTED CEILING LEGEND

- 1.1 CEILING TYPE HEIGHT 9'-6"
- INDICATES PAINTED GWB CEILING
- SPRINKLER HEAD; SEE FIRE PROTECTION DWGS
- MECHANICAL SUPPLY AND RETURN; SEE MECH DWGS
- MECHANICAL EQUIPMENT; SEE MECH DWGS
- MECHANICAL EQUIPMENT (ABOVE CEILING); SEE MECH DWGS
- ATTIC ACCESS

LIGHT SYMBOL LEGEND

- 48" LIGHT FIXTURE
- 2x2 RECESSED LIGHT FIXTURE
- 2x4 RECESSED LIGHT FIXTURE
- 12" X 12" RECESSED LIGHT FIXTURE
- 4" RECESSED LIGHT FIXTURE
- WALL MOUNT LIGHT FIXTURE
- CONTINUOUS FLUORESCENT LIGHT FIXTURE
- MURAL SIGN LIGHT

NOTE: EMERGENCY LIGHTING, EXIT SIGNS ETC ARE NOT SHOWN ON THIS DRAWING AT THIS TIME.



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114 Main Street
Laconia, NH 03246
Phone: 603.228.8880


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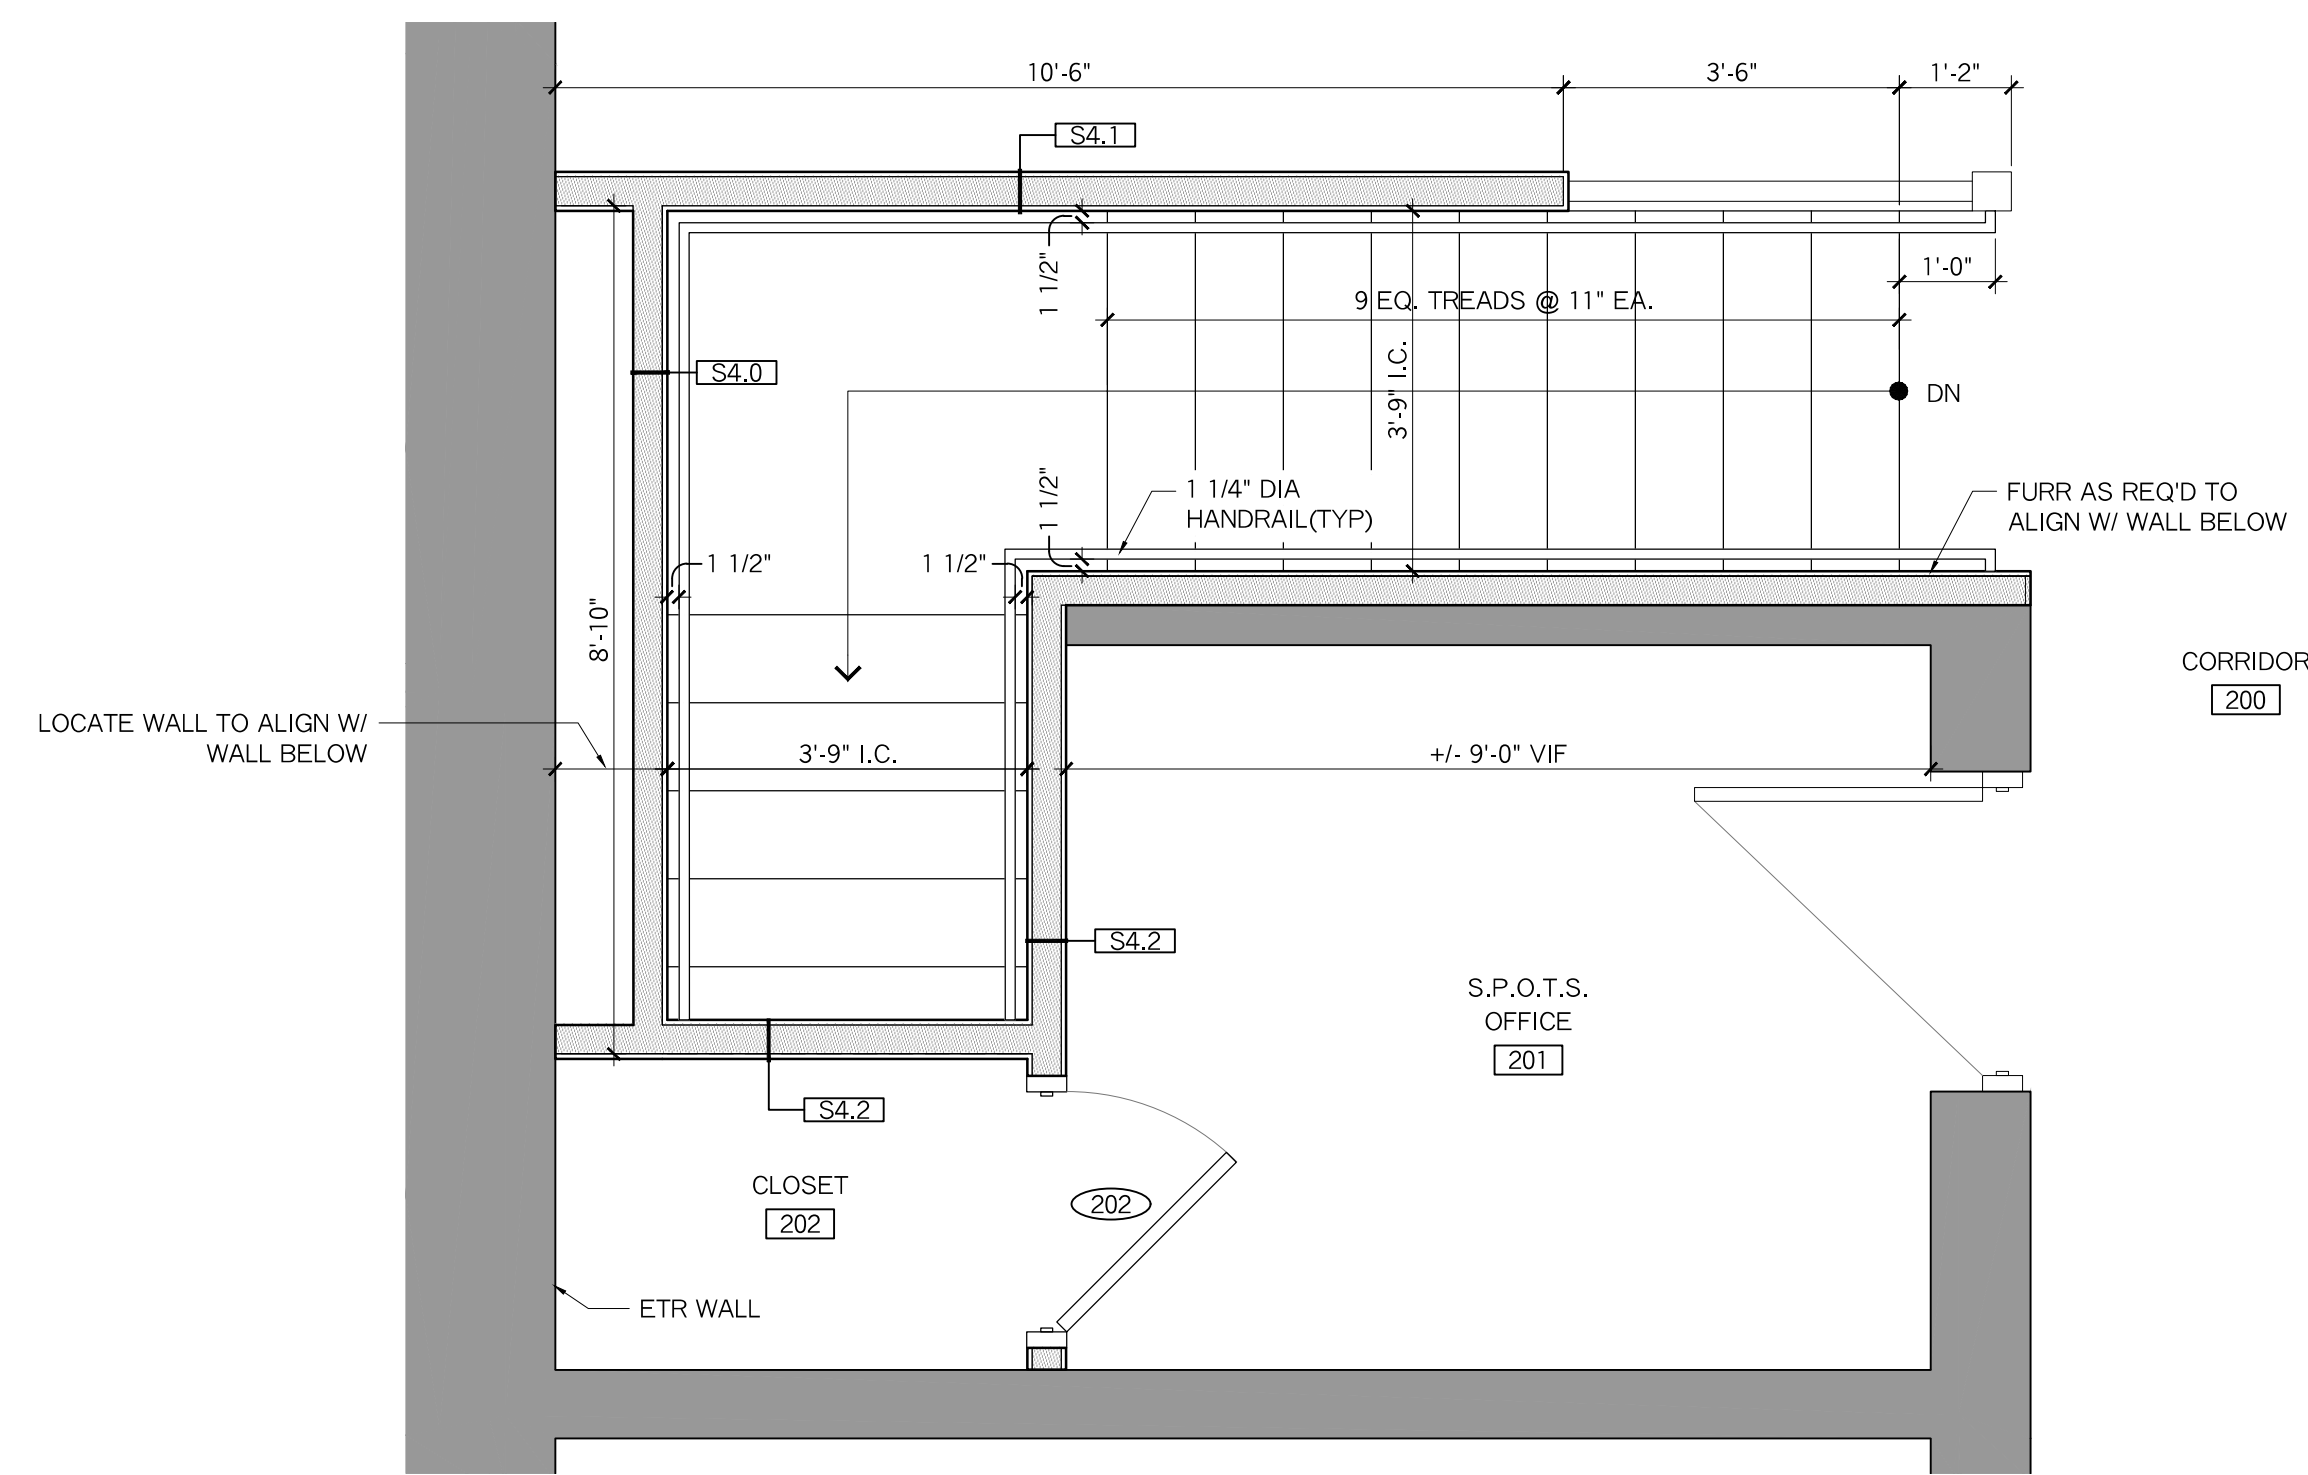
PROJECT: BELKNAP COUNTY SUPERIOR COURT
64 Court St # 5, Laconia, NH 03246
Interior Renovations
REFLECTED CEILING PLANS

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CHECKED BY:	A.M.
DATE:	OCTOBER 09, 2023
REVISION	DATE


SHEET NUMBER: **A110**




2 STAIR PLAN @ FIRST FLOOR LEVEL
1/2" = 1'-0"

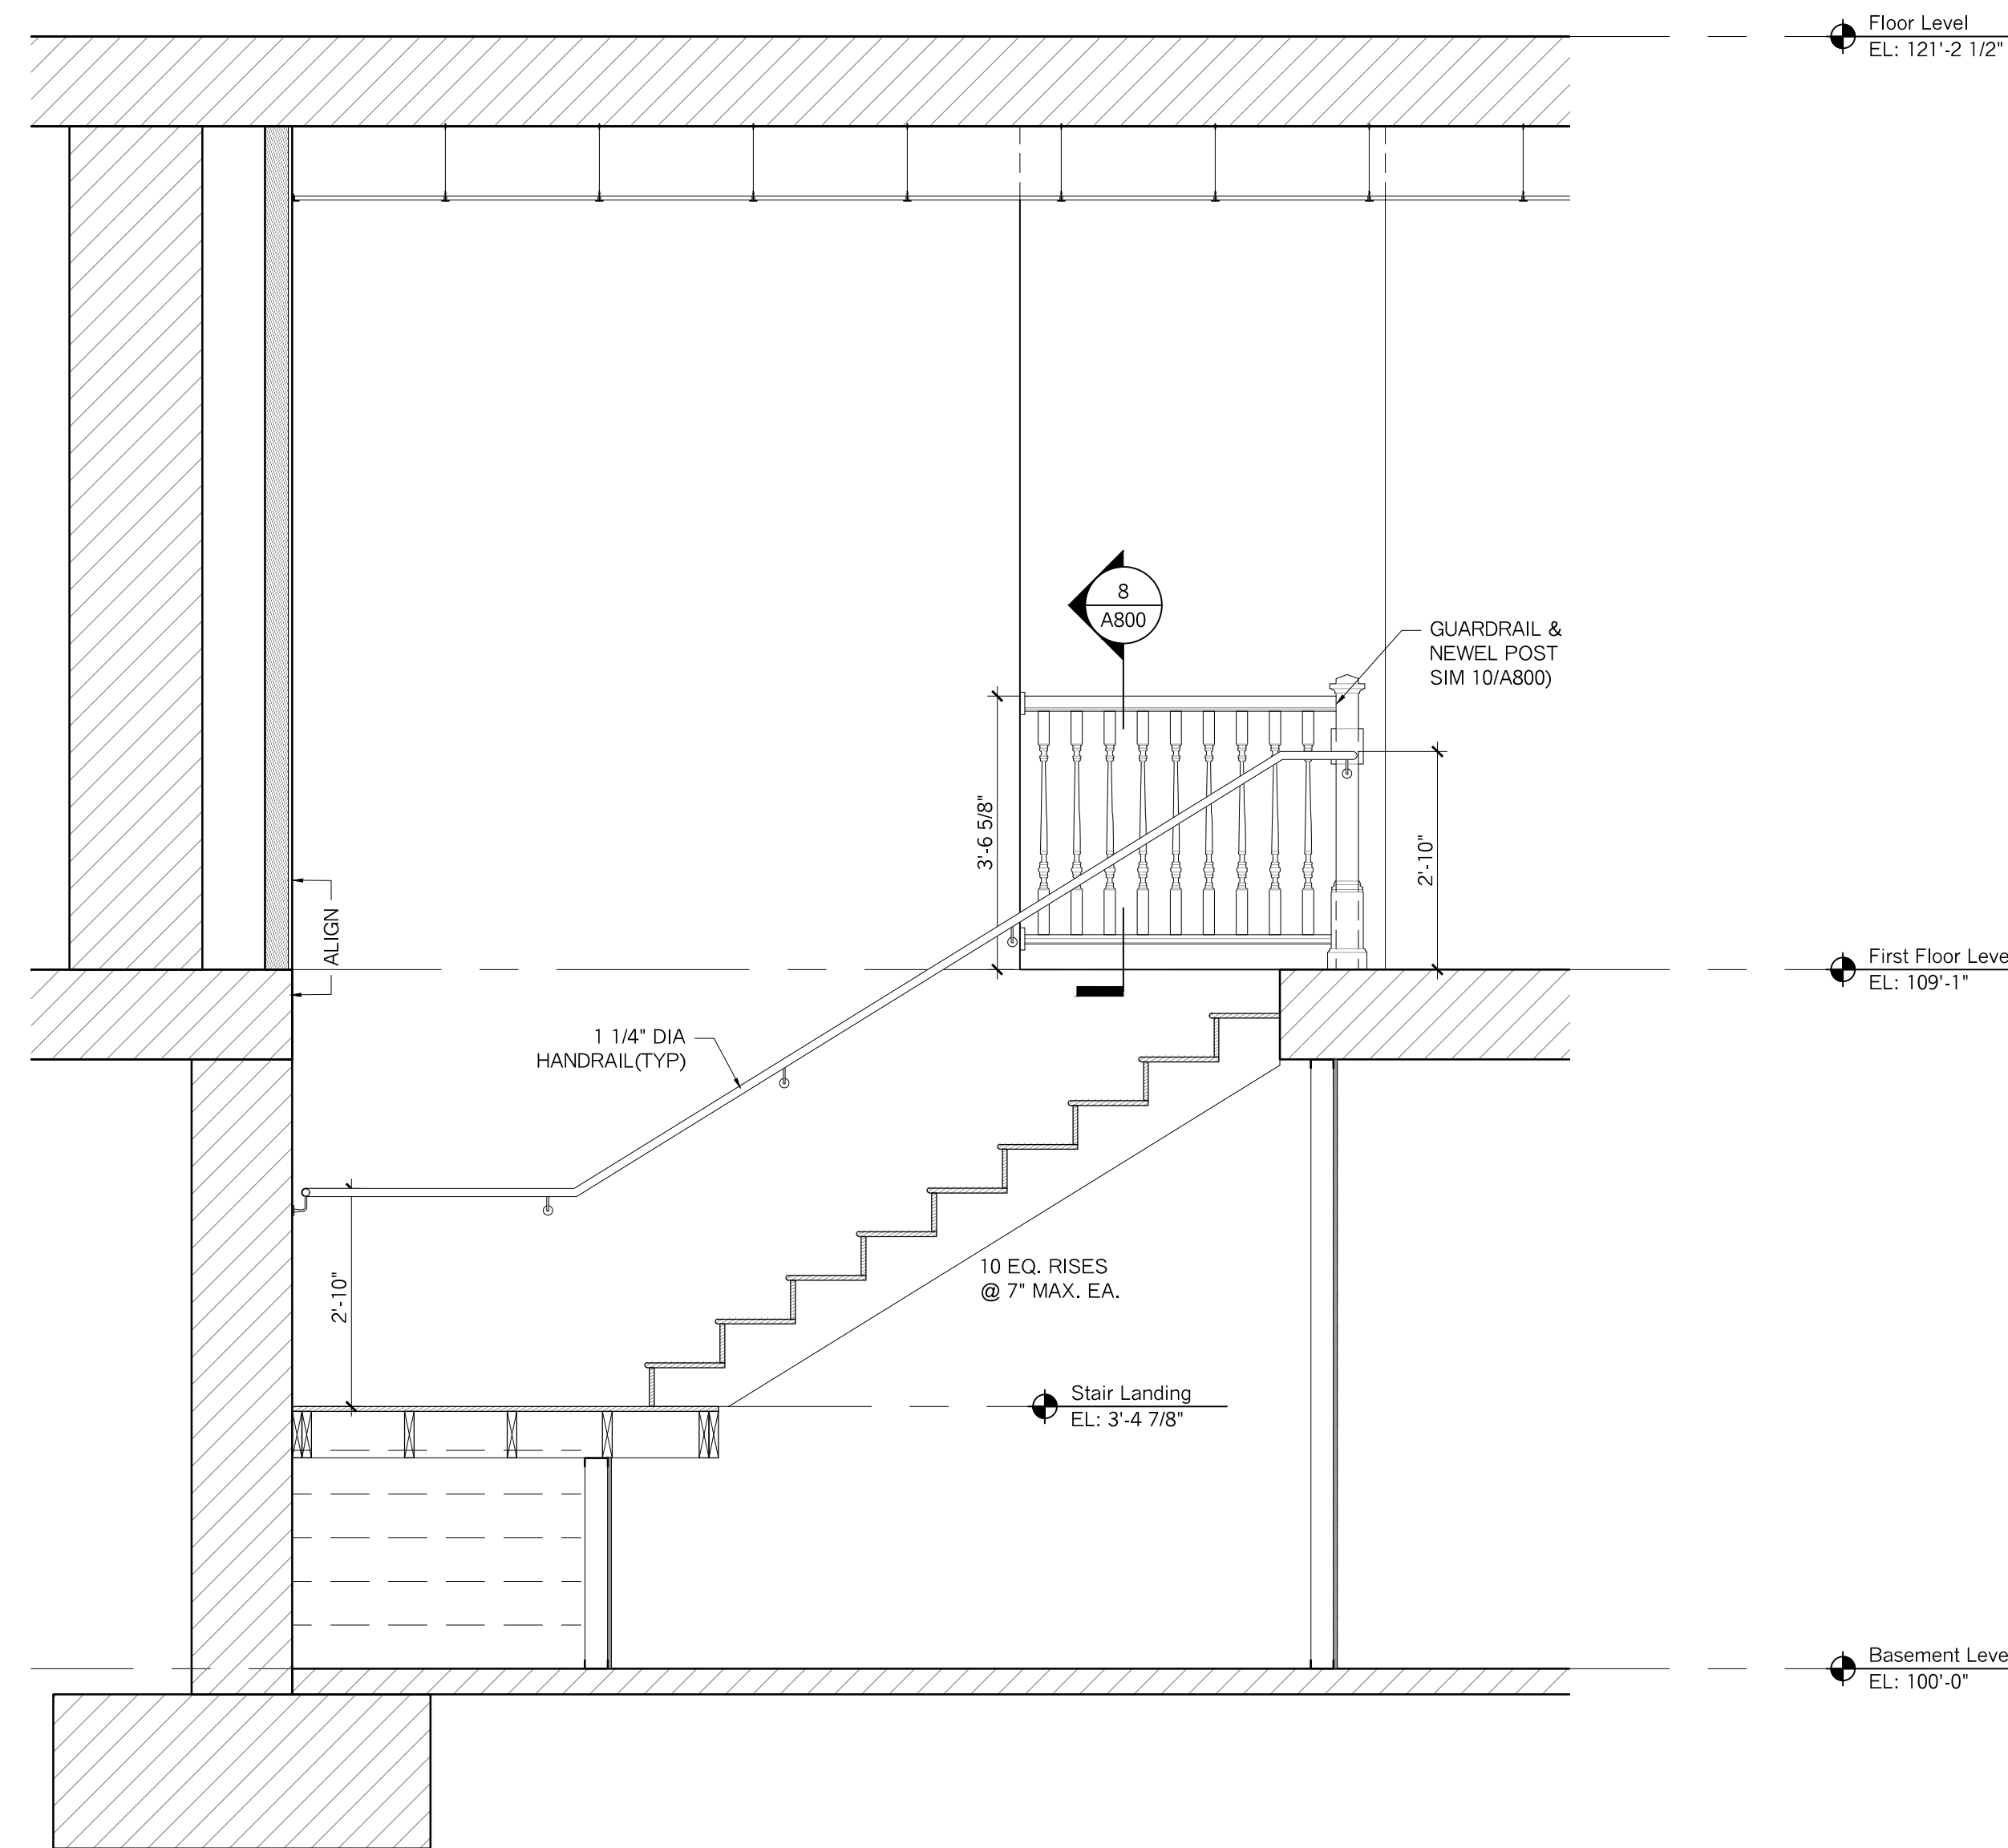

2 STAIR PLAN @ FIRST FLOOR LEVEL
1/2" = 1'-0"

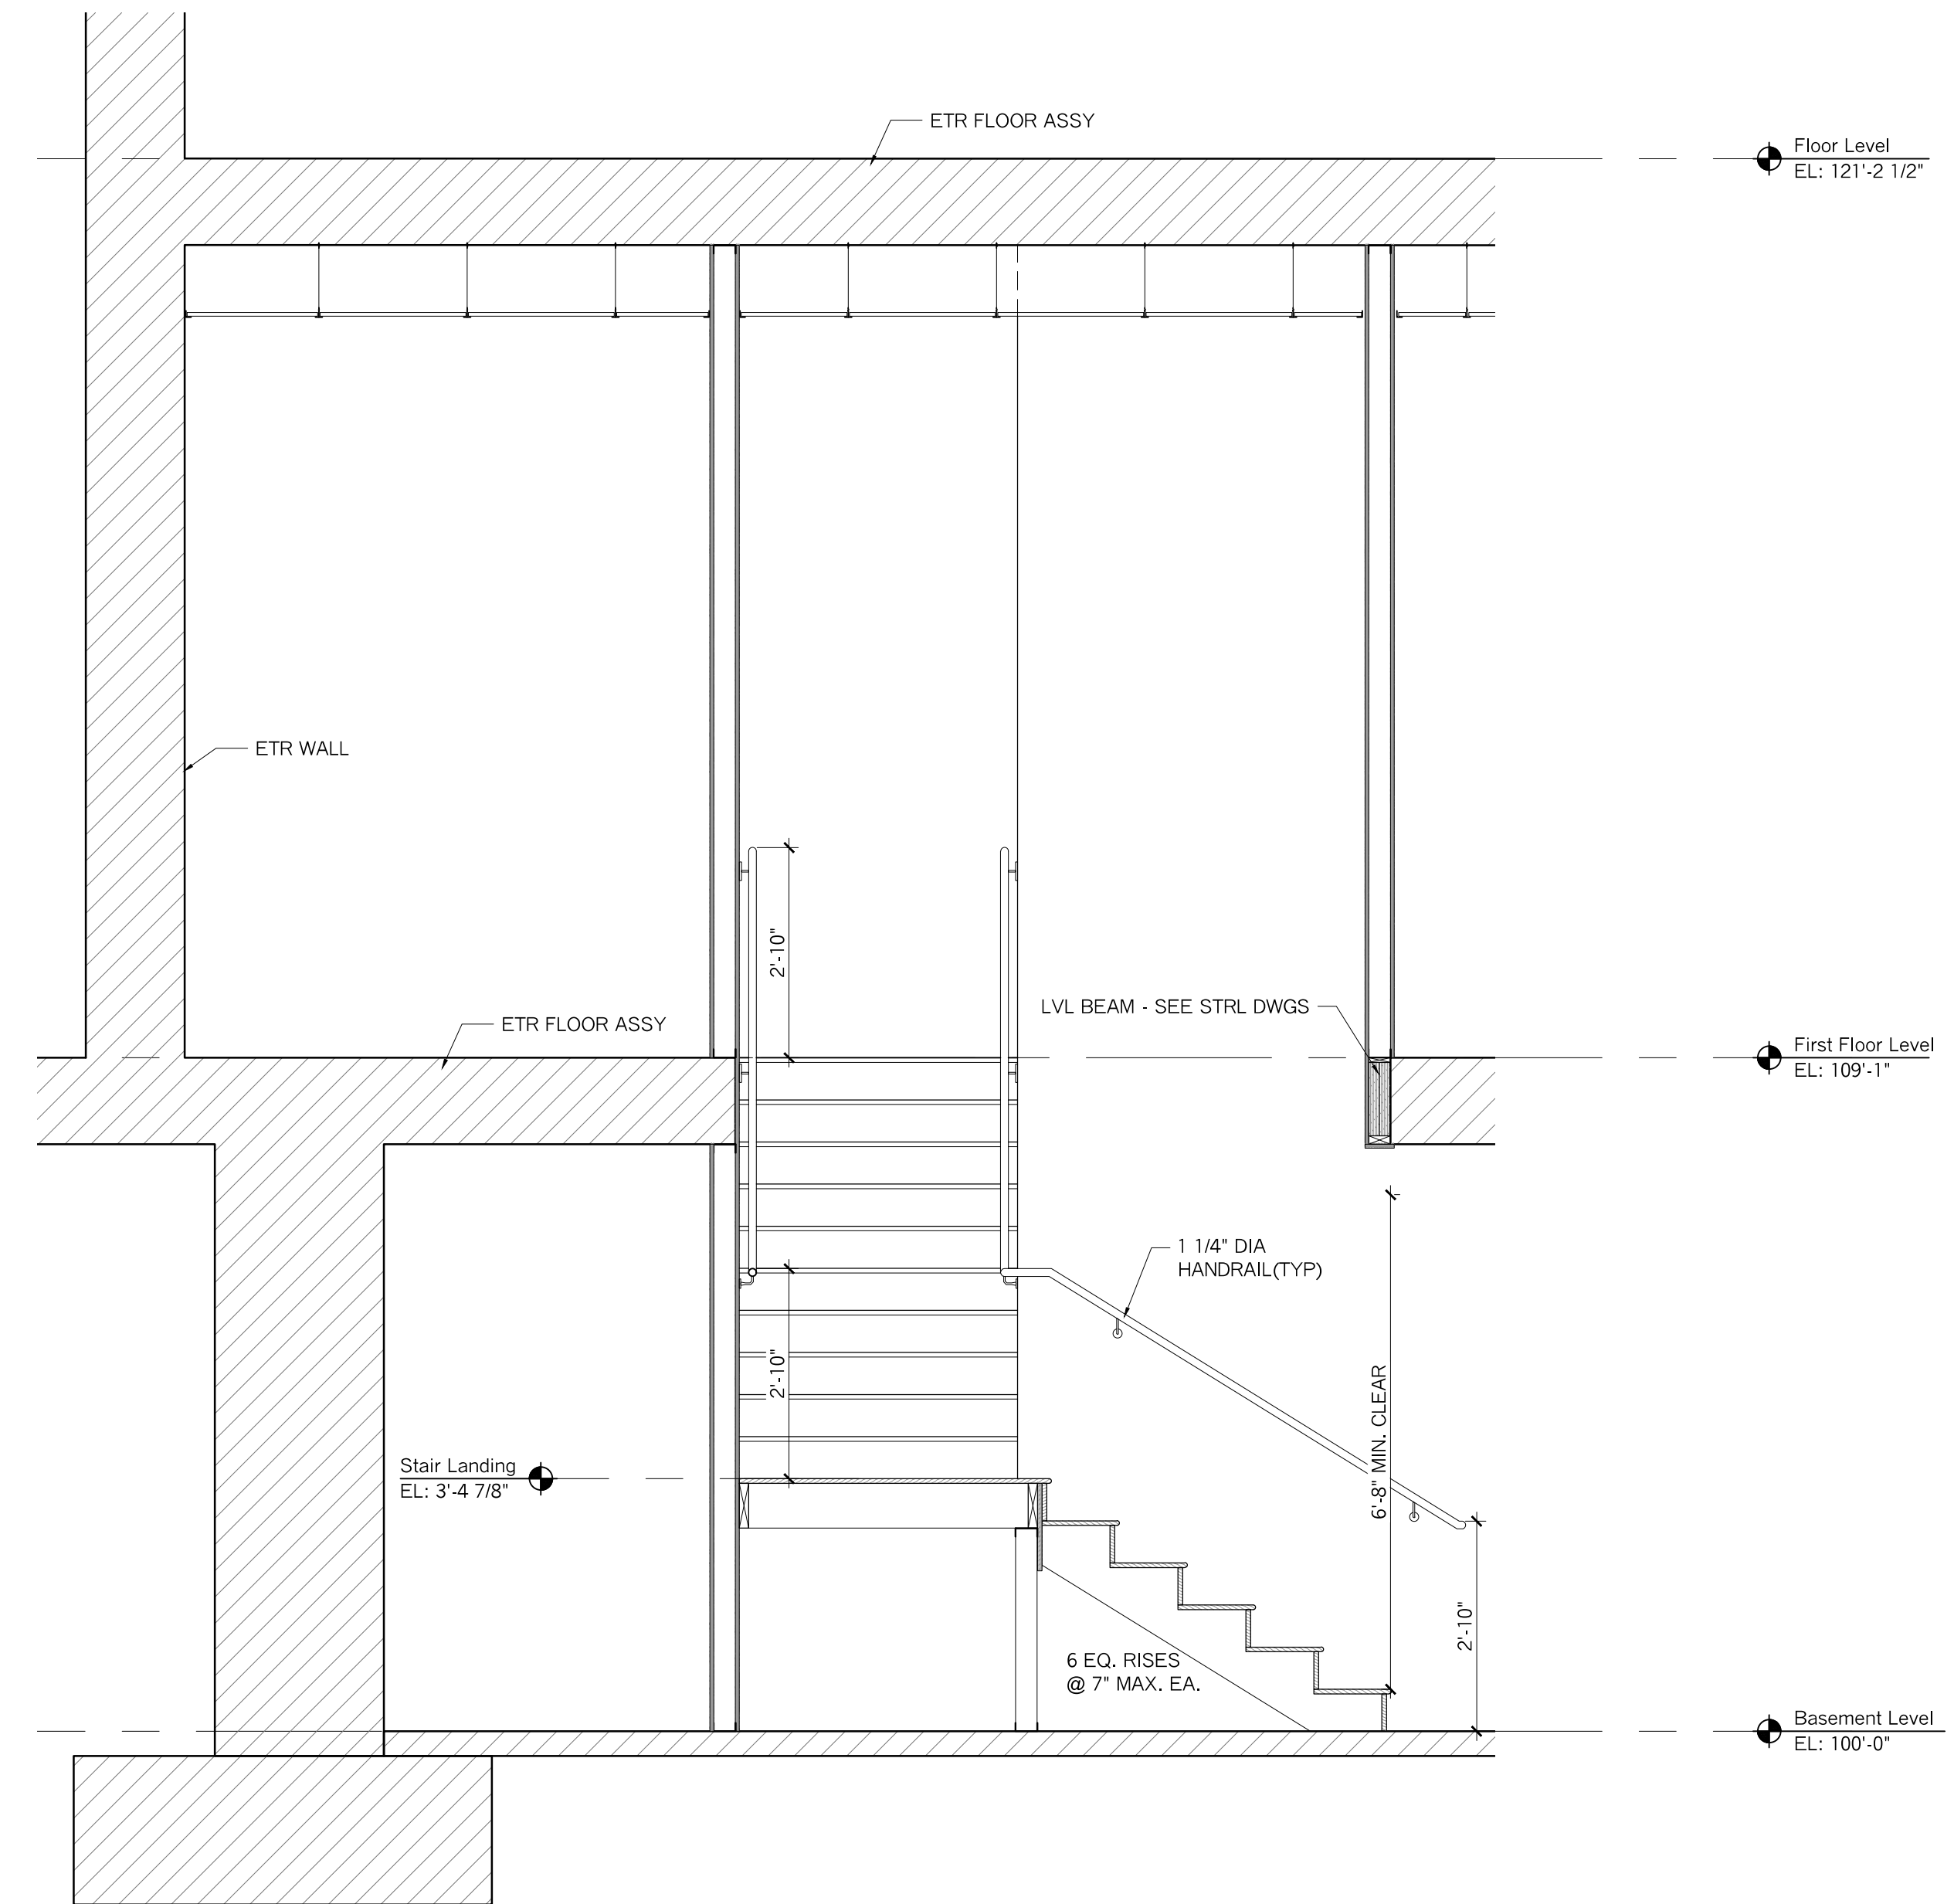

1 STAIR PLAN @ BASEMENT LEVEL
1/2" = 1'-0"

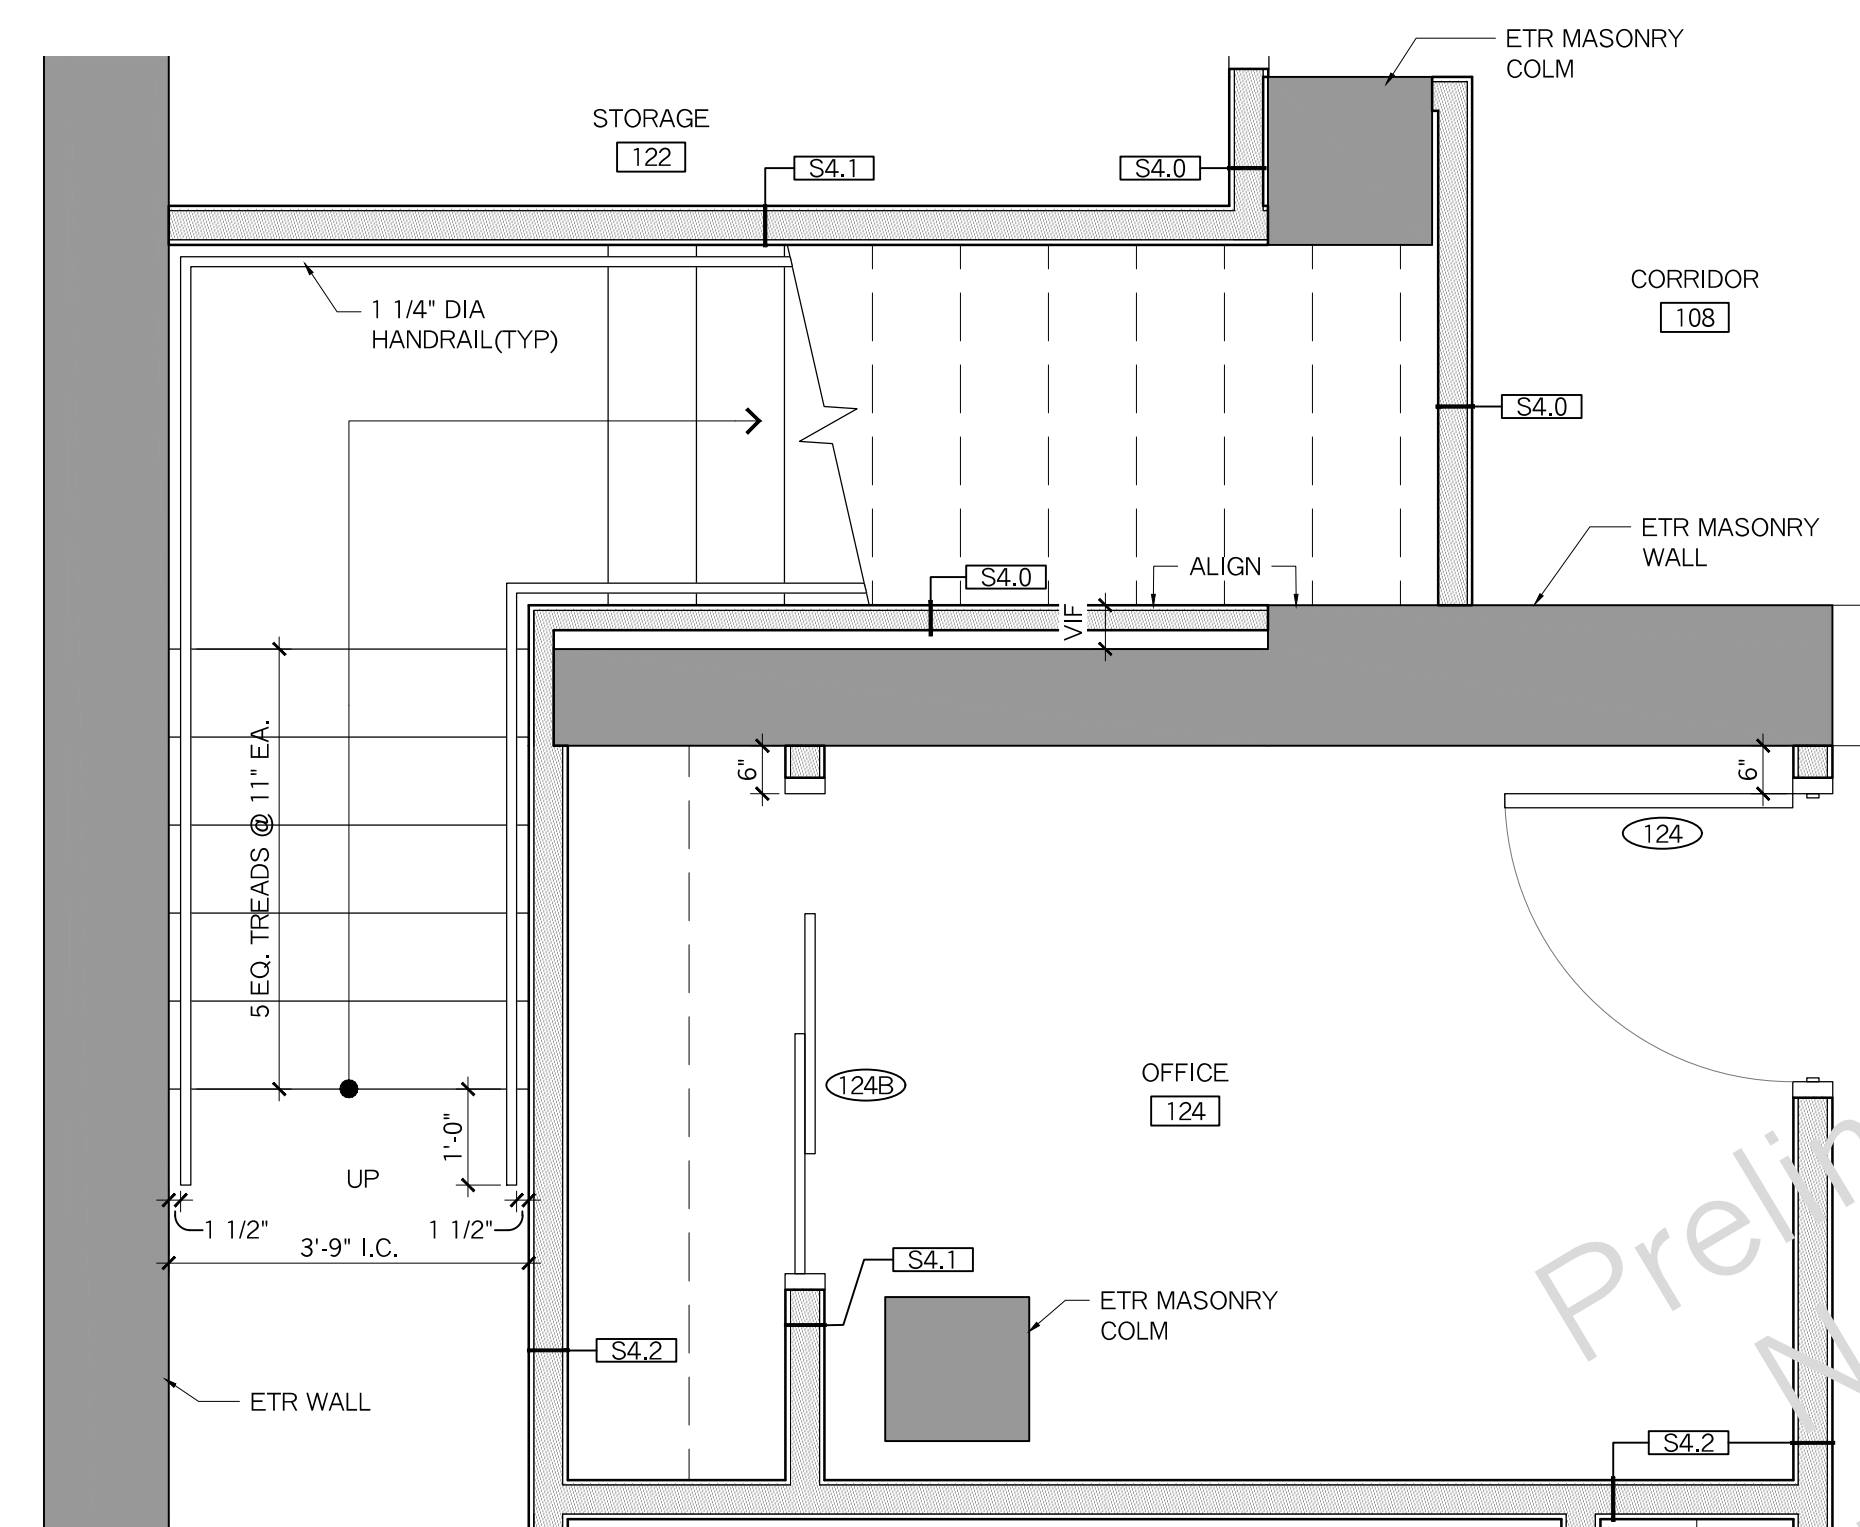

1 STAIR PLAN @ BASEMENT LEVEL
1/2" = 1'-0"



OWNER:
MEP ENGINEER: WJ Engineering Assoc. PA
111 Elm Street
Laconia, NH 03246
Phone: 603.228.8880

PHONE: 603.228.8880
WWW.SHEER.COM



PROJECT: BELKNAP COUNTY SUPERIOR COURT
64 Court St # 5, Laconia, NH 03246
Interior Renovations
ENLARGED STAIR PLANS

ISSUED: DESIGN DEVELOPMENT
JOB NO: 23-011
DRAWN BY: V.A.D.
CHECKED BY: A.M.
DATE: OCTOBER 09, 2023

REVISION	DATE

SHEET NUMBER:

A410

DOOR & FRAME SCHEDULE											HARDWARE											REMARKS		
ID #	DESCRIPTION	DOOR					FRAME		LBL	SIGNAGE		LOCK FUNCTION	LATCH / LOCK SET	ACCESS CONTROL/ ELECTRIC STRIKE SEE NOTE 11	EXIT DEVICE	CLOSER	DEADBOLT	8" TALL KICKPLATE	30" TALL KICKPLATE	SWEEP	SOUND GASKET		WEATHER STRIPPING	8" D' STYLE PULL
		DIMENSIONS	TYPE	MATL	GLAZ	TYPE	MATL	TYPE	TEXT															
108	EXISTING TO REMAIN	EXISTING																						
108A	EXTR HINGED SINGLE	36"W X 80"H		STEEL	GL-1	A	HM																	
108B																								
108C				ALUM																				
108D																								
108E	HINGED SINGLE			WD																				
109				WD																				
110A																								
110B																								
111																								
112																								
113																								
114																								
115																								
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125																								
125B																								
127																								
128																								
129																								
130																								
131																								
133																								
134																								
135																								

DOOR AND HARDWARE NOTES

- G.C. TO VERIFY FRAME THROAT DEPTHS OF ALL DOORS.
- VERIFY R.O. W/ DOOR MANUF.
- PROVIDE TEMPERED/INSULATED GLASS AS REQUIRED; PROVIDE RATED GLASS WHERE REQUIRED.
- PROVIDE DOOR STOPS, WALL OR FLOOR, EACH DOOR AS REQ.
- COORDINATE KEYING REQUIREMENTS WITH OWNER.
- ALL EXTERIOR DOORS TO HAVE ADA COMPLIANT SILLS WITH THERMAL BRAKE.
- PROVIDE COAT/ROBE HOOKS ON REAR OF DOOR @ ALL OFFICES, TYP. BRUSHED ALUMINUM FINISH.
- ALL DOOR LEAFS LESS THAN 4'-0" WIDE TO RECEIVE MIN. OF 3 HEAVY DUTY HINGES.
- ALL DOOR SIGNAGE NAMING SHOULD BE CONFIRMED/ COORDINATED W/ THE OWNER.
- GARAGE DOOR: BASED ON C.H.I. OVERHEAD DOORS. SEE SPECIFICATIONS.
- DOORS DESIGNATED FOR ACCESS CONTROLS SYSTEMS TO BE PROVIDED WITH ELECTRIC STRIKE AND POWER SUPPLY BY CONTRACTOR. ACCESS CONTROL SYSTEM CONNECTED TO ELECTRIC STRIKE TO BE PROVIDED AND INSTALLED BY OWNERS SECURITY VENDOR.
- ALL DOOR HARDWARE SHALL BE BRUSHED ALUMINUM FINISH.



OWNER:
MEP ENGINEER: WJ Engineering Assoc. PA
175 State St
Laconia, NH 03246
Phone: 603.228.8880

PHONE: 603.228.8880
WWW.SHEER.COM


WINDOW SCHEDULE									
WIN #	TYPE	DIMENSIONS (W" x H")	SILL HGT AFF	MATERIAL	DETAILS			GLAZ	REMARKS
					HEAD	JAMB	SILL		
A	DOUBLE HUNG	30 x 55	30"	VINYL	3/A600	1/A600	2/A600	GL-1	
B	(2) DOUBLE HUNG	74 x 55	30"	VINYL	3/A600	1/A600	2/A600	GL-1	FACTORY MULLED
C	(3) DOUBLE HUNG	98 x 55	30"	VINYL	3/A600	1/A600	2/A600	GL-1	FACTORY MULLED
D	AWNING	30 x 28	59"	VINYL	3/A600	1/A600	2/A600	GL-1	

WINDOW NOTES


- EXTERIOR WINDOWS ARE BASED ON MARVIN 'ELEVATE' UNITS.
- VERIFY EXISTING R.O. SIZES AND ADJUST UNIT SIZES ACCORDINGLY TO FIT PER MANUFACTURERS INSTALLATION REQUIREMENTS.
- ALL OPERABLE WINDOWS HAVE SCREENS.
- WINDOW DIMENSIONS ARE UNIT SIZES.
- PROVIDE WINDOWS W/ CLEAR FINISH INTERIOR ON WOOD SURFACES.
- ARCHITECT TO SELECT HARDWARE COLOR FROM STANDARD SELECTION.
- EXTERIOR CLADDING COLOR TO BE WHITE (MATCH EXISTING).
- G.C. TO VERIFY WINDOW QUANTITY.
- INSTALL WINDOWS W. FLASHING PER MANUF. REQ.
- PROVIDE TEMPERED GLASS WHERE REQUIRED BY CODE

GLAZING TYPES

- GL-1: 1" INSULATED GLASS, LOW-E 366.
- GL-2: 1/4" CLEAR TEMPERED.
- GL-3: 3/16" RATED CERAMIC TGP 'FIRELITE PLUS' OR EQ.
- GL-4: 1/2" CLEAR TEMPERED.

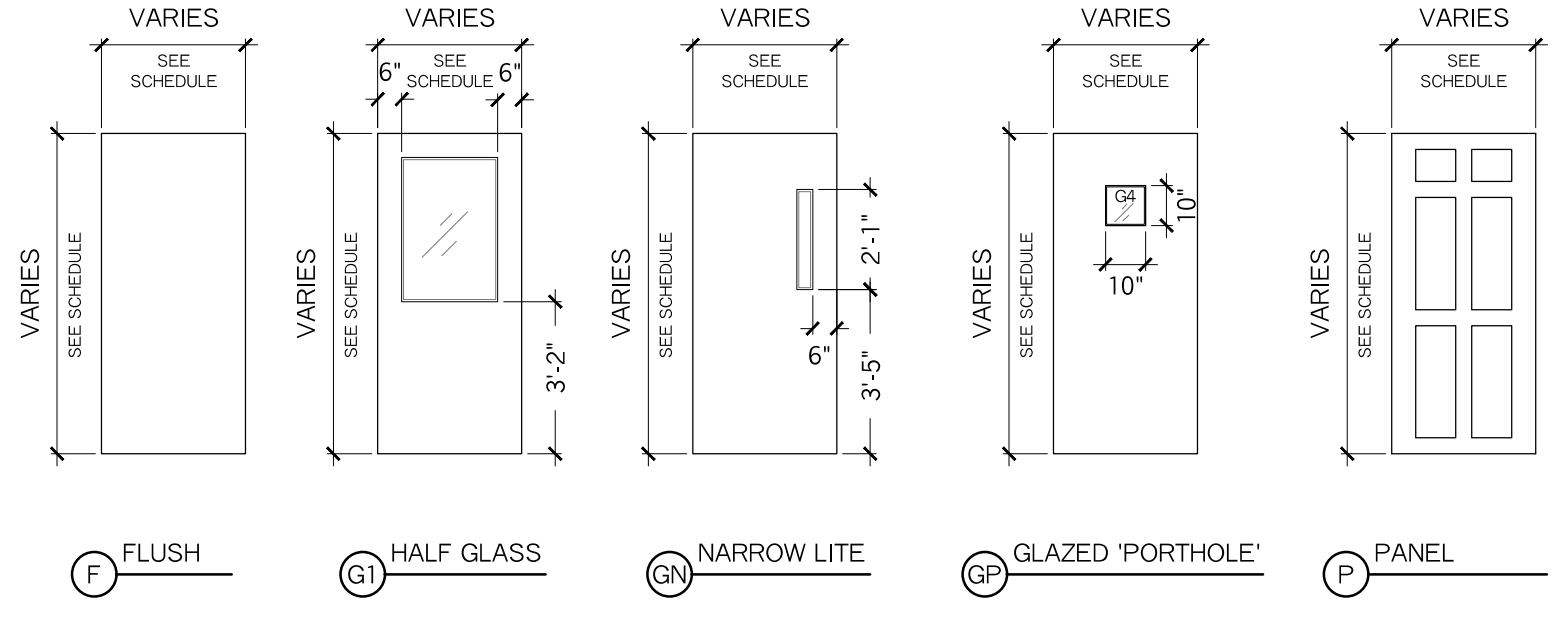

DOOR TYPES
1/4" = 1'-0"

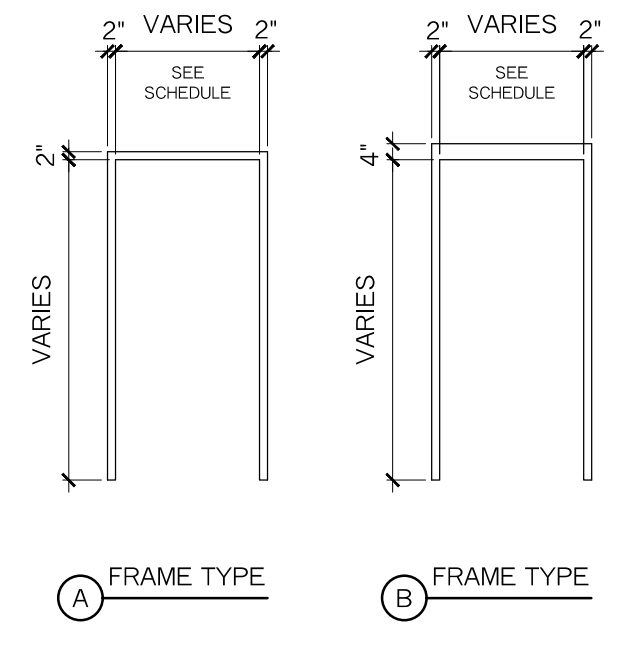

FRAME TYPES
1/4" = 1'-0"
NOTE: PROVIDE THERMALLY BROKEN FRAMES AT EXTERIOR DOORS

5 BORROWED HEAD DETAIL
3" = 1'-0"

4 BORROWED LITE JAMB / SILL DETAIL
3" = 1'-0"

3 TYPICAL WINDOW HEAD DETAIL
3" = 1'-0"

2 TYPICAL WINDOW SILL DETAIL
3" = 1'-0"


1 TYPICAL WINDOW JAMB DETAIL
3" = 1'-0"

PROJECT: BELKNAP COUNTY SUPERIOR COURT
64 Court St # 5, Laconia, NH 03246
Interior Renovations
DOOR & WINDOW SCHEDULES, FRAMES & DETAILS


ISSUED: DESIGN DEVELOPMENT
JOB NO: 23-011
DRAWN BY: V.A.D.
CHECKED BY: A.M.
DATE: 09/26/23

SHEET NUMBER: **A600**


Preliminary
Not for
Construction

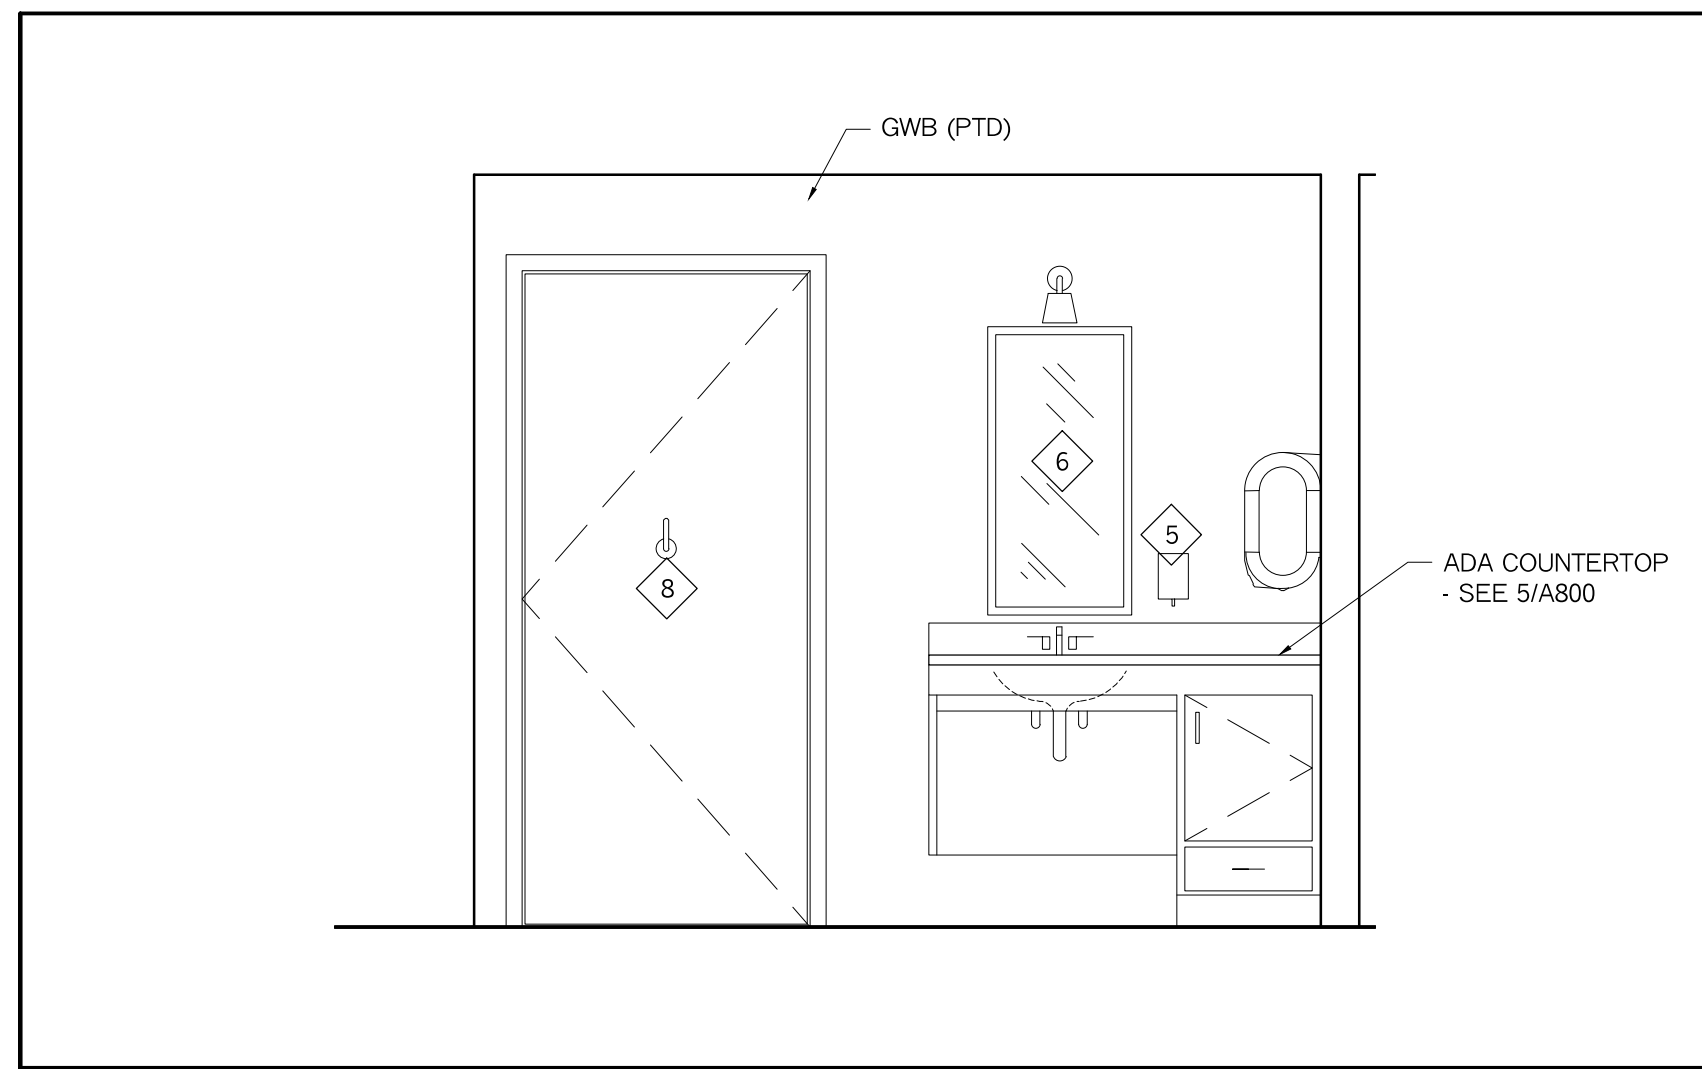


11 INTERIOR ELEVATION @ RESTROOM 129
1/2" = 1'-0"

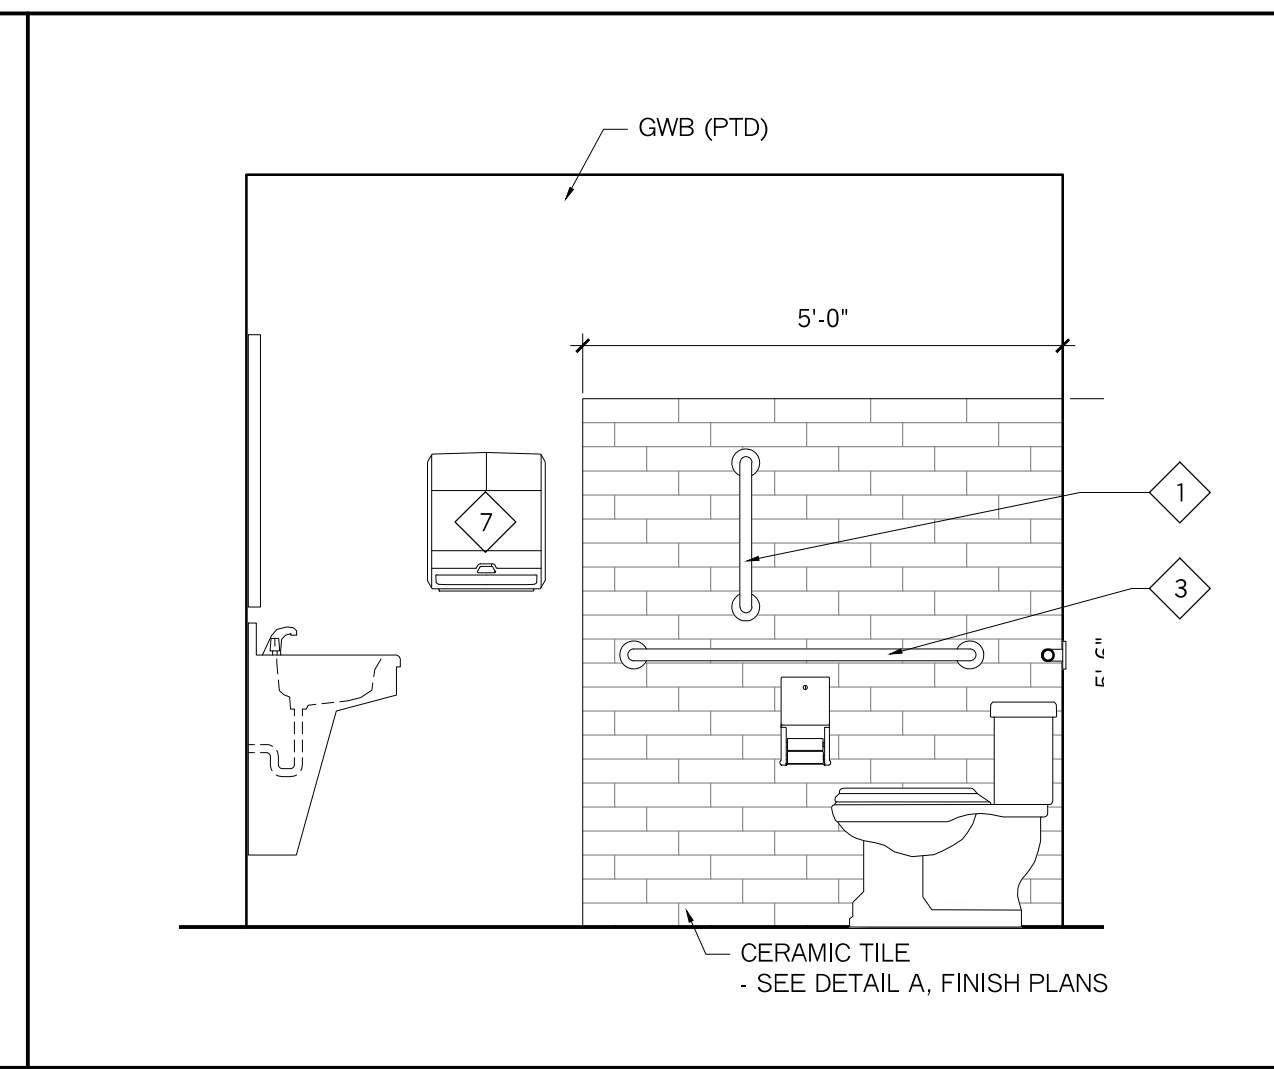


10 INTERIOR ELEVATION @ RESTROOM 129
1/2" = 1'-0"

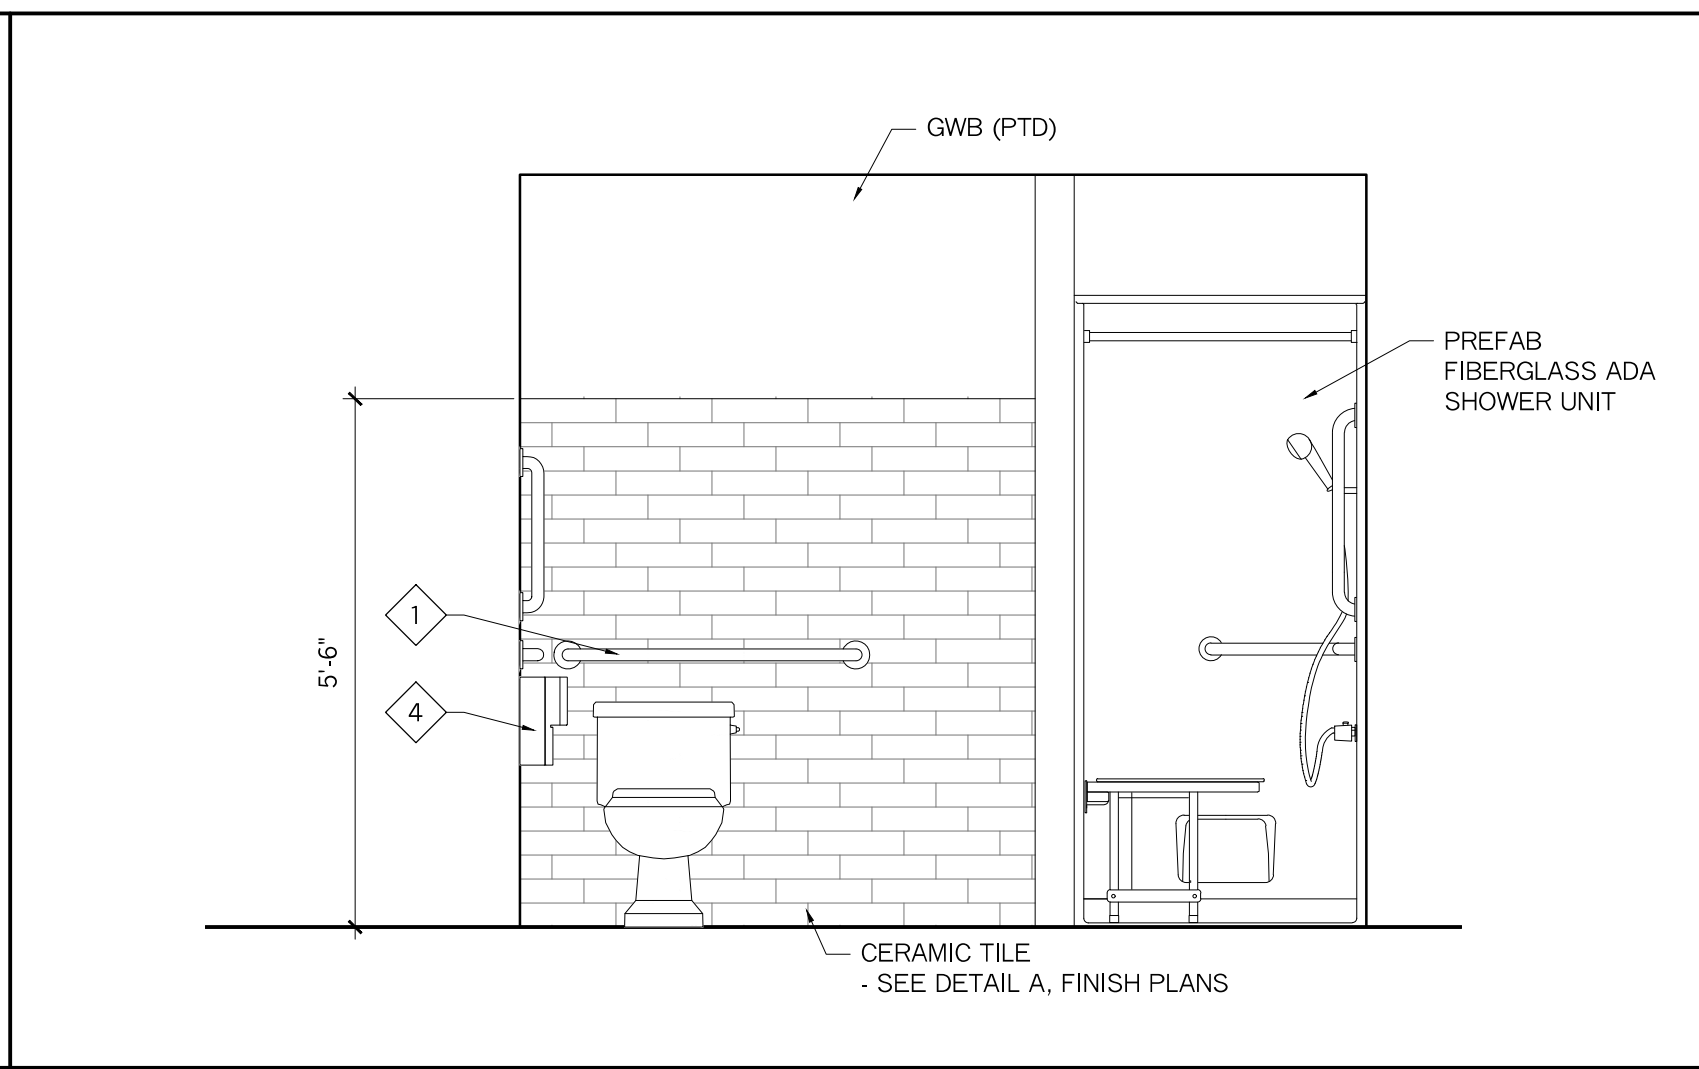


9 INTERIOR ELEVATION @ RESTROOM 129
1/2" = 1'-0"

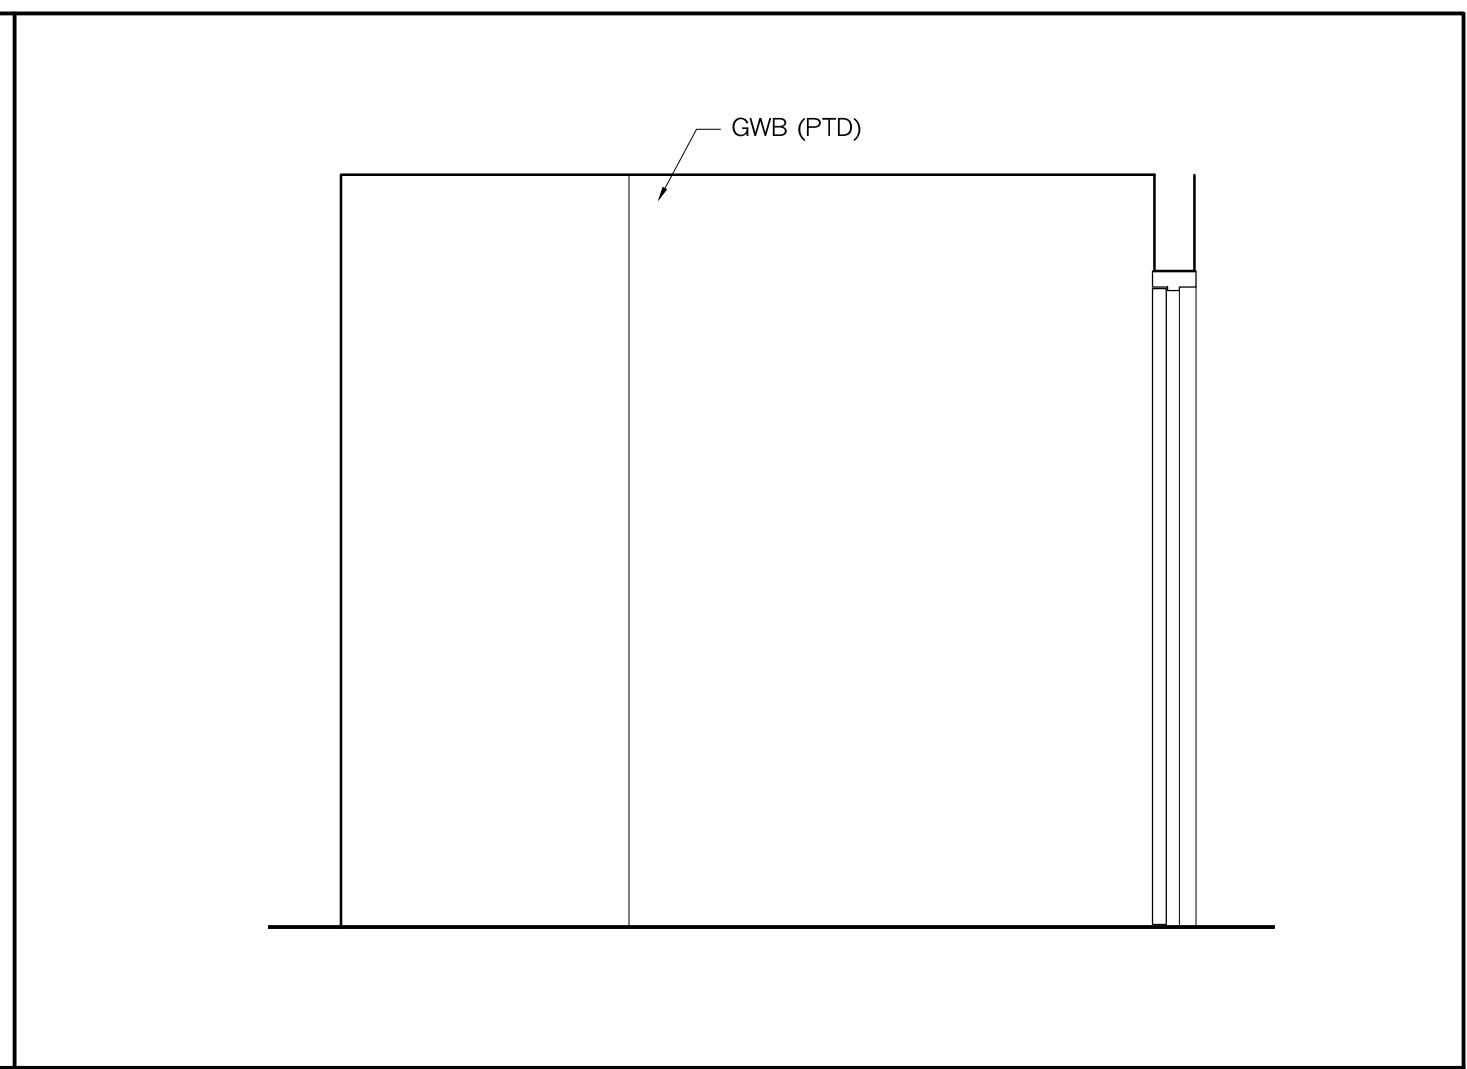


8 INTERIOR ELEVATION @ RESTROOM 129
1/2" = 1'-0"

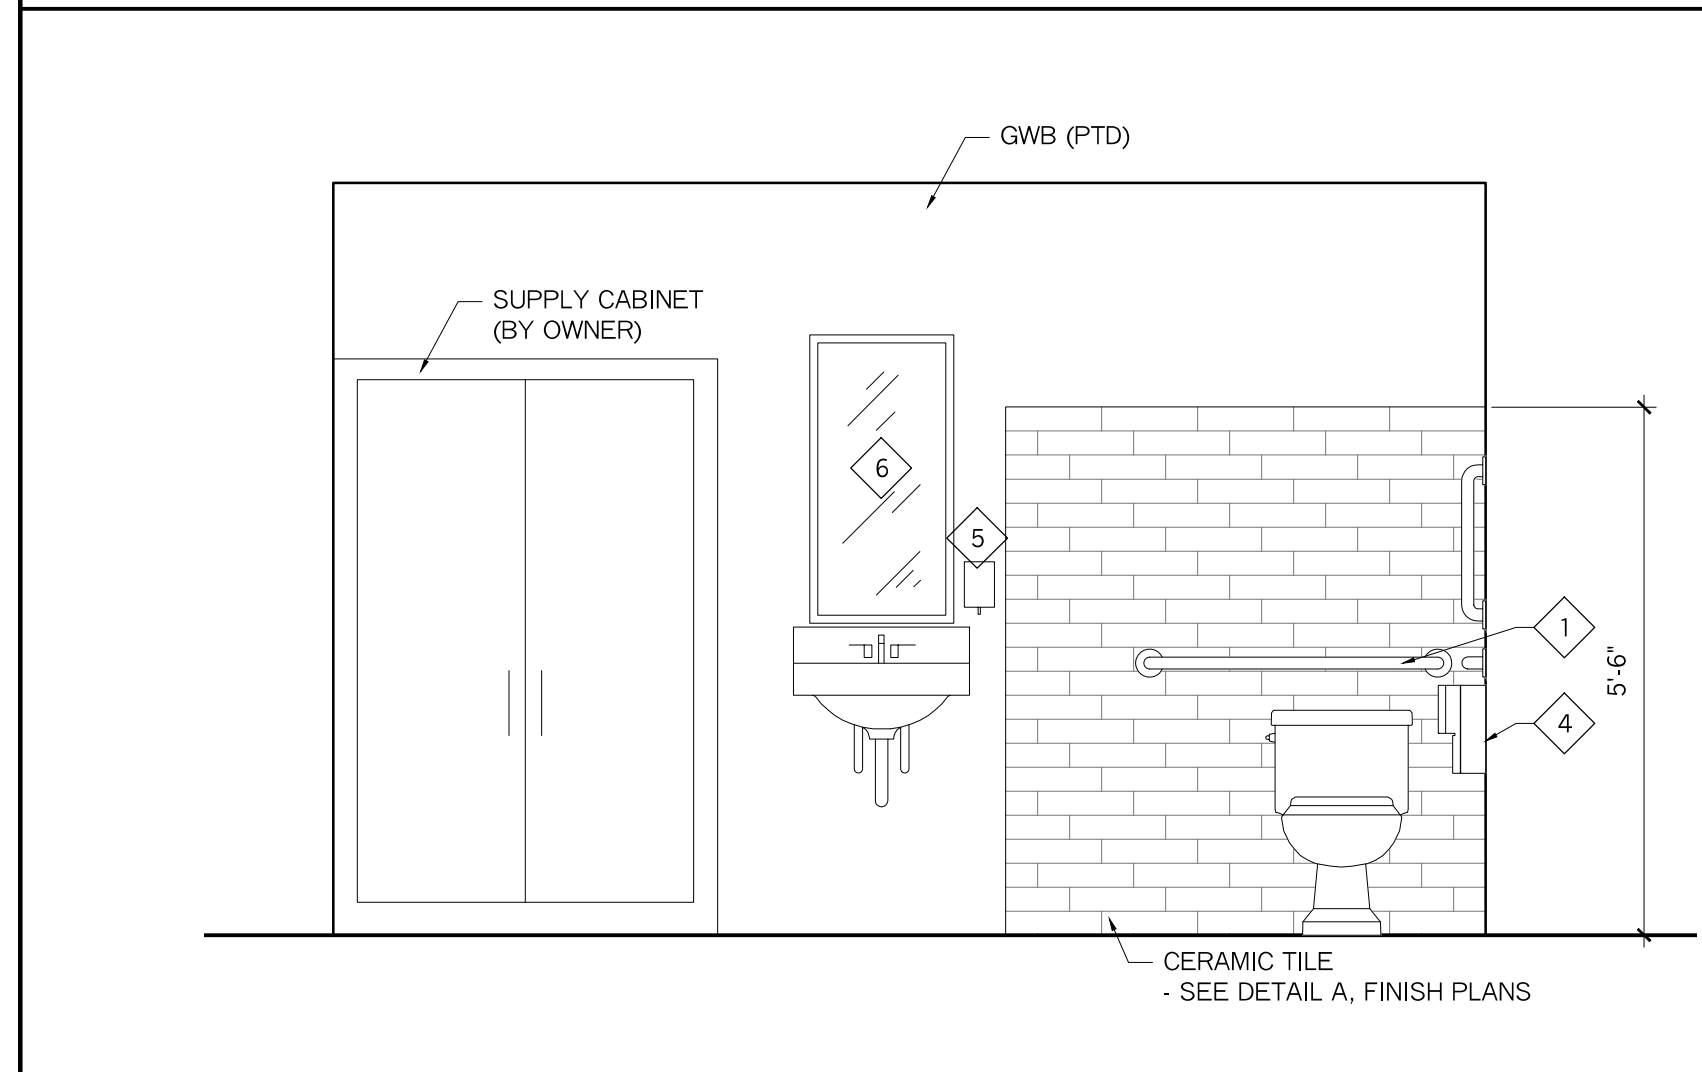


7 INTERIOR ELEVATION @ RESTROOM 115
1/2" = 1'-0"

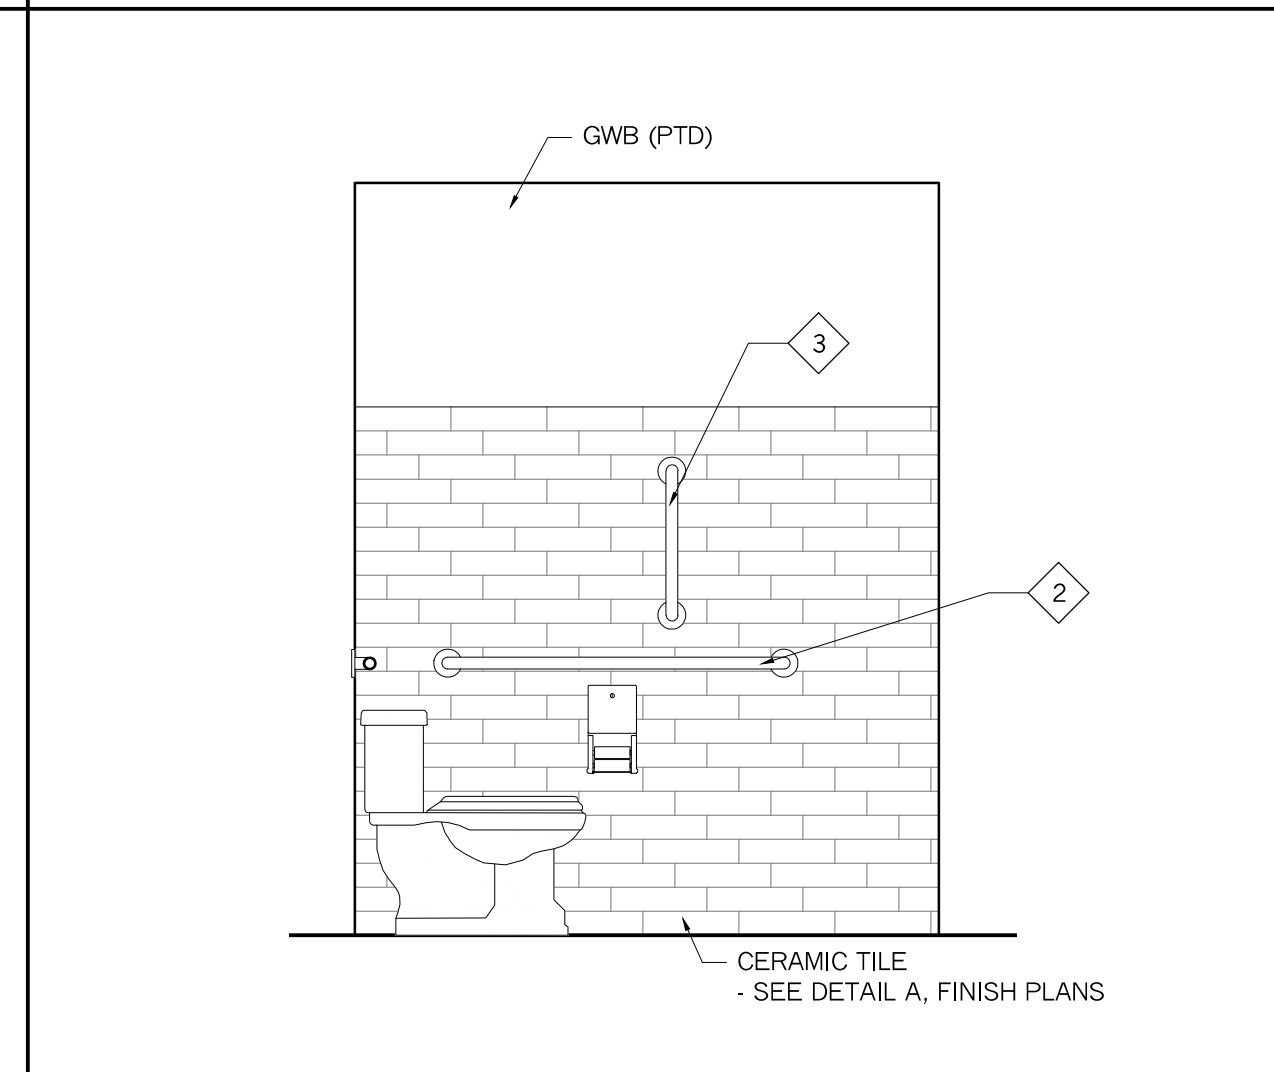


6 INTERIOR ELEVATION @ RESTROOM 115
1/2" = 1'-0"

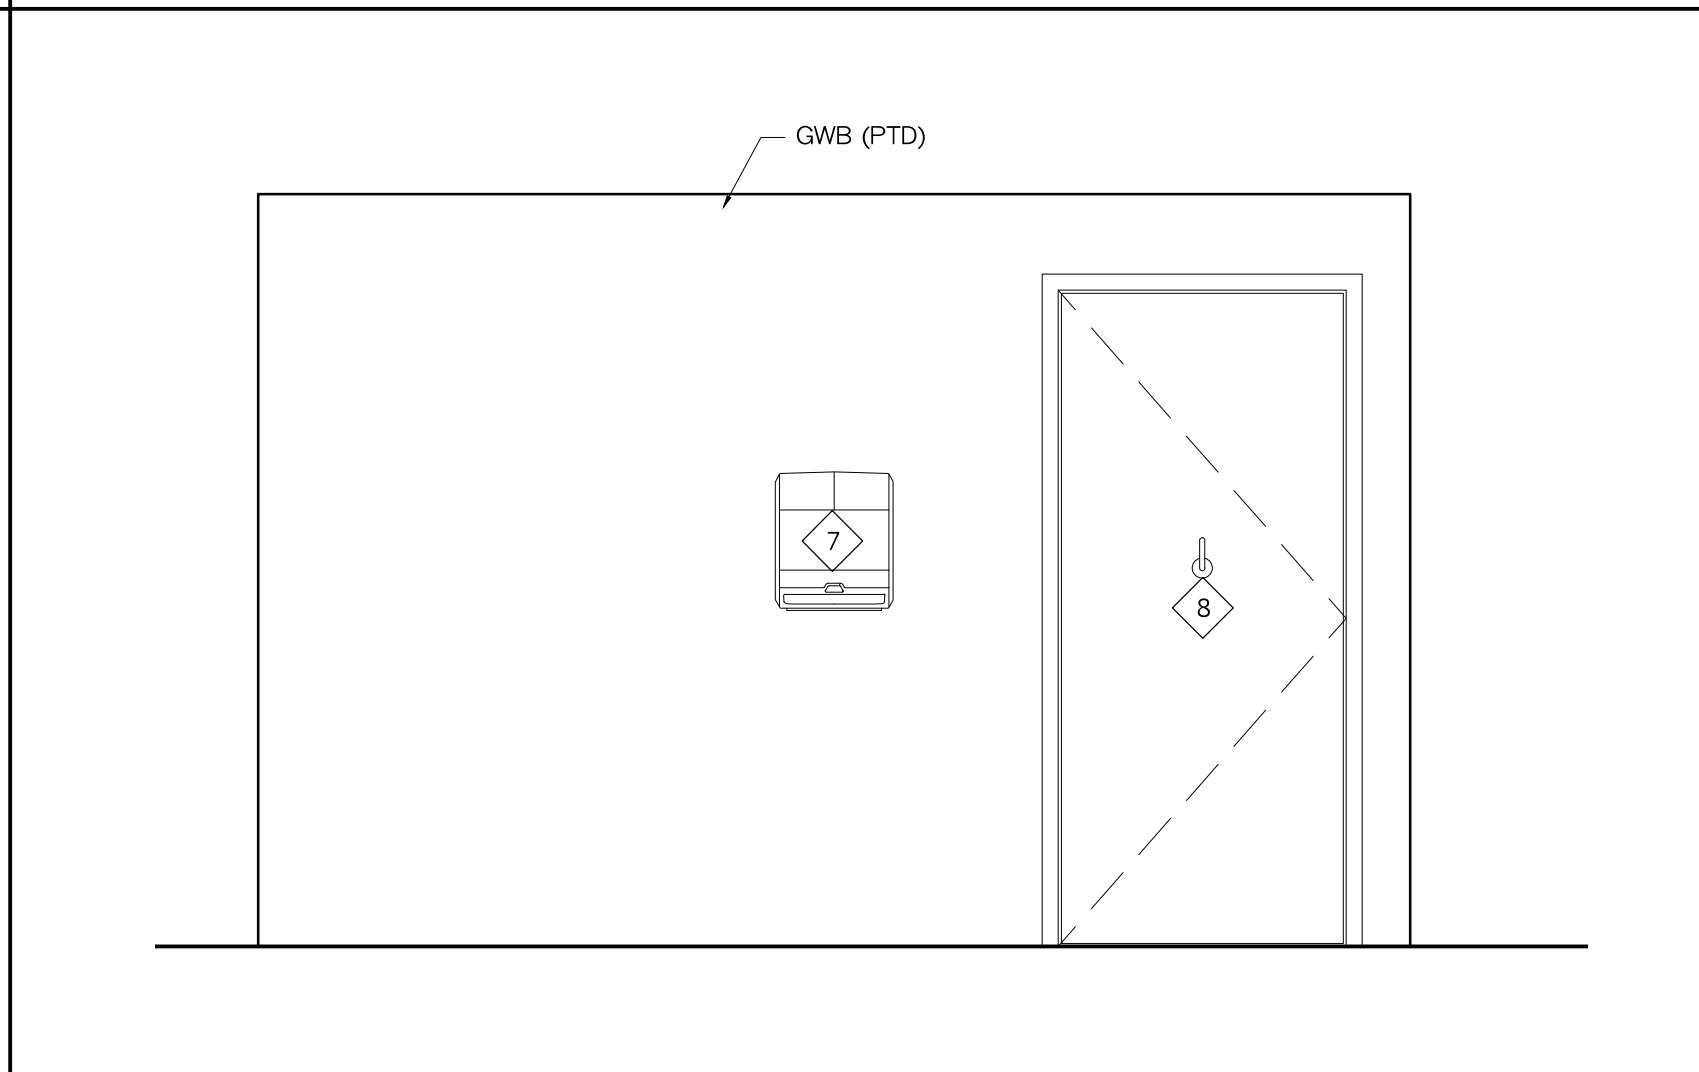


5 INTERIOR ELEVATION @ RESTROOM 115
1/2" = 1'-0"

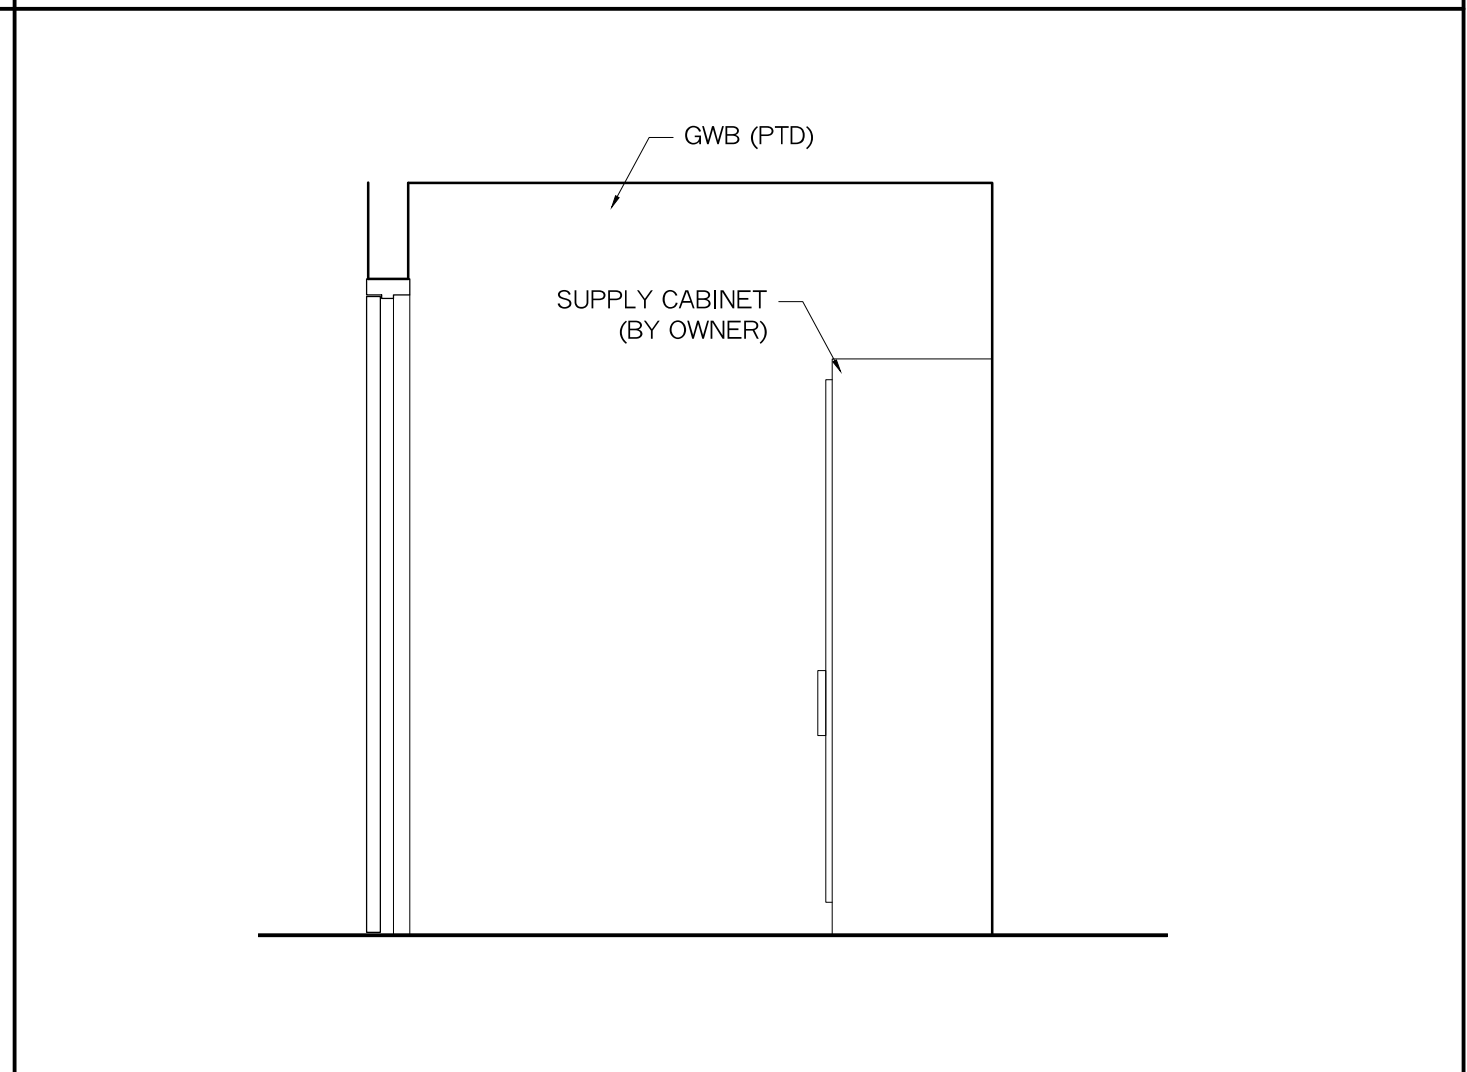


4 INTERIOR ELEVATION @ RESTROOM 115
1/2" = 1'-0"

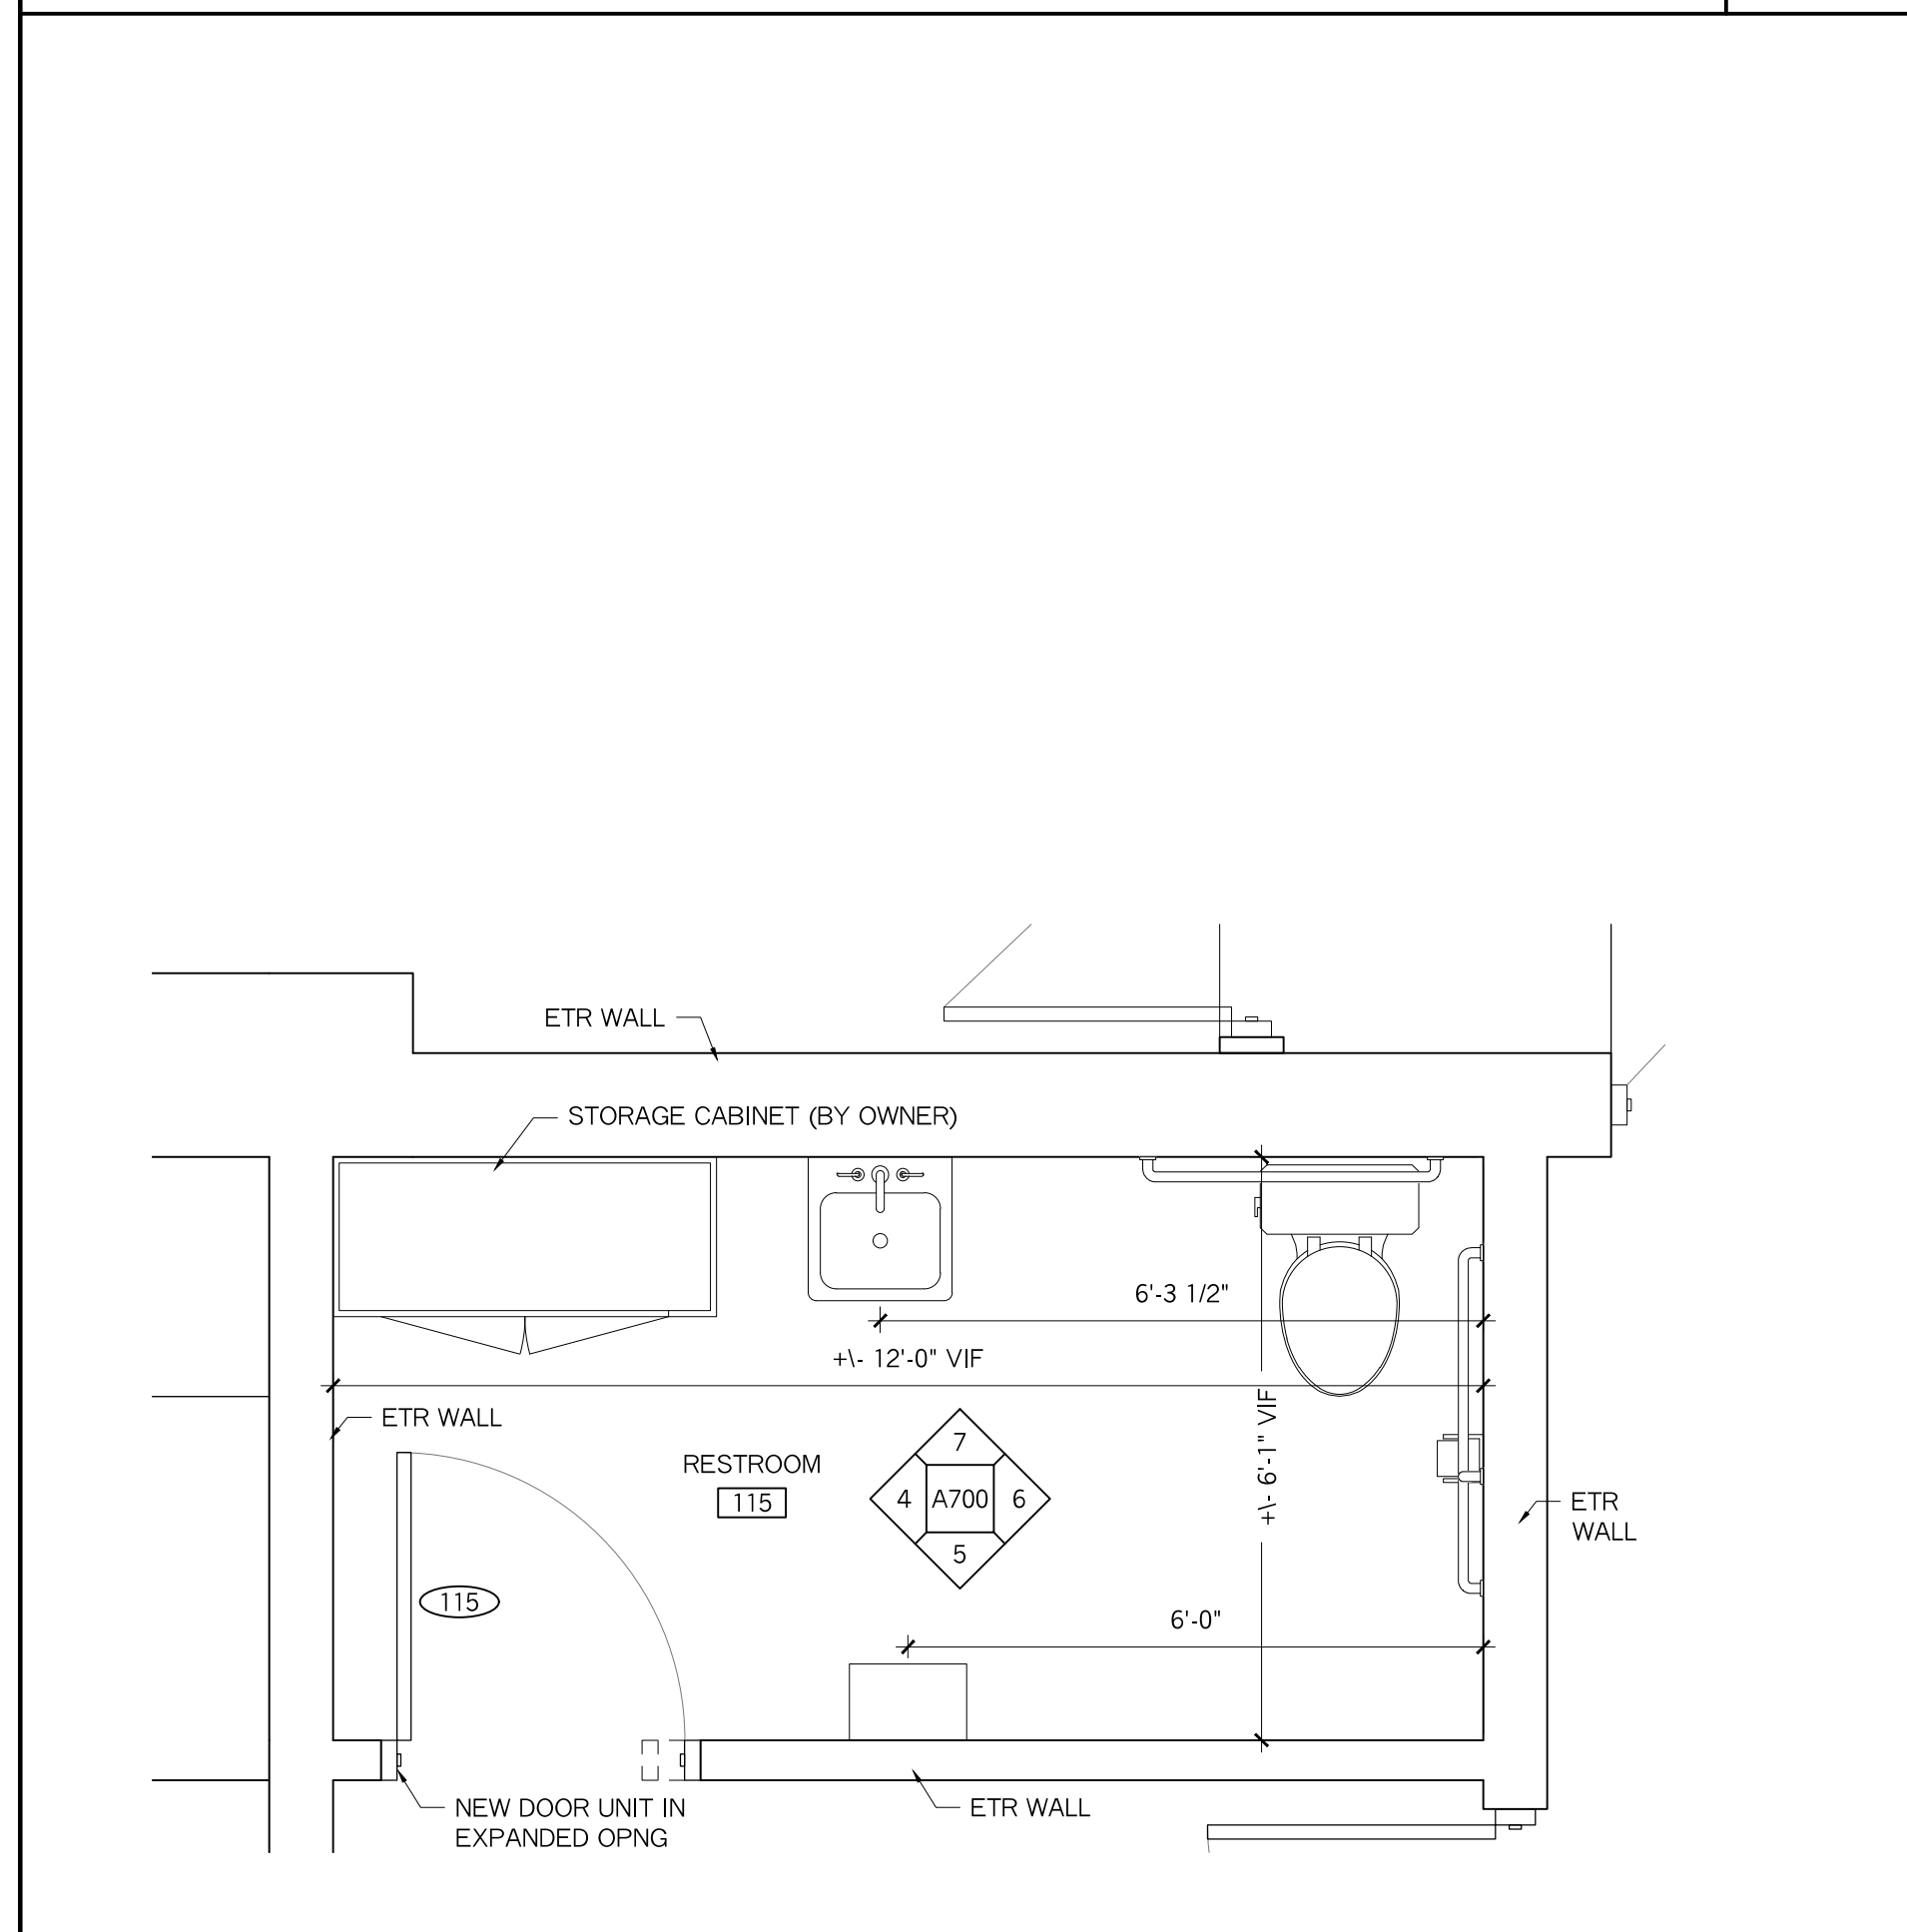

3 ENLARGED PLAN @ RESTROOM 115
1/2" = 1'-0"

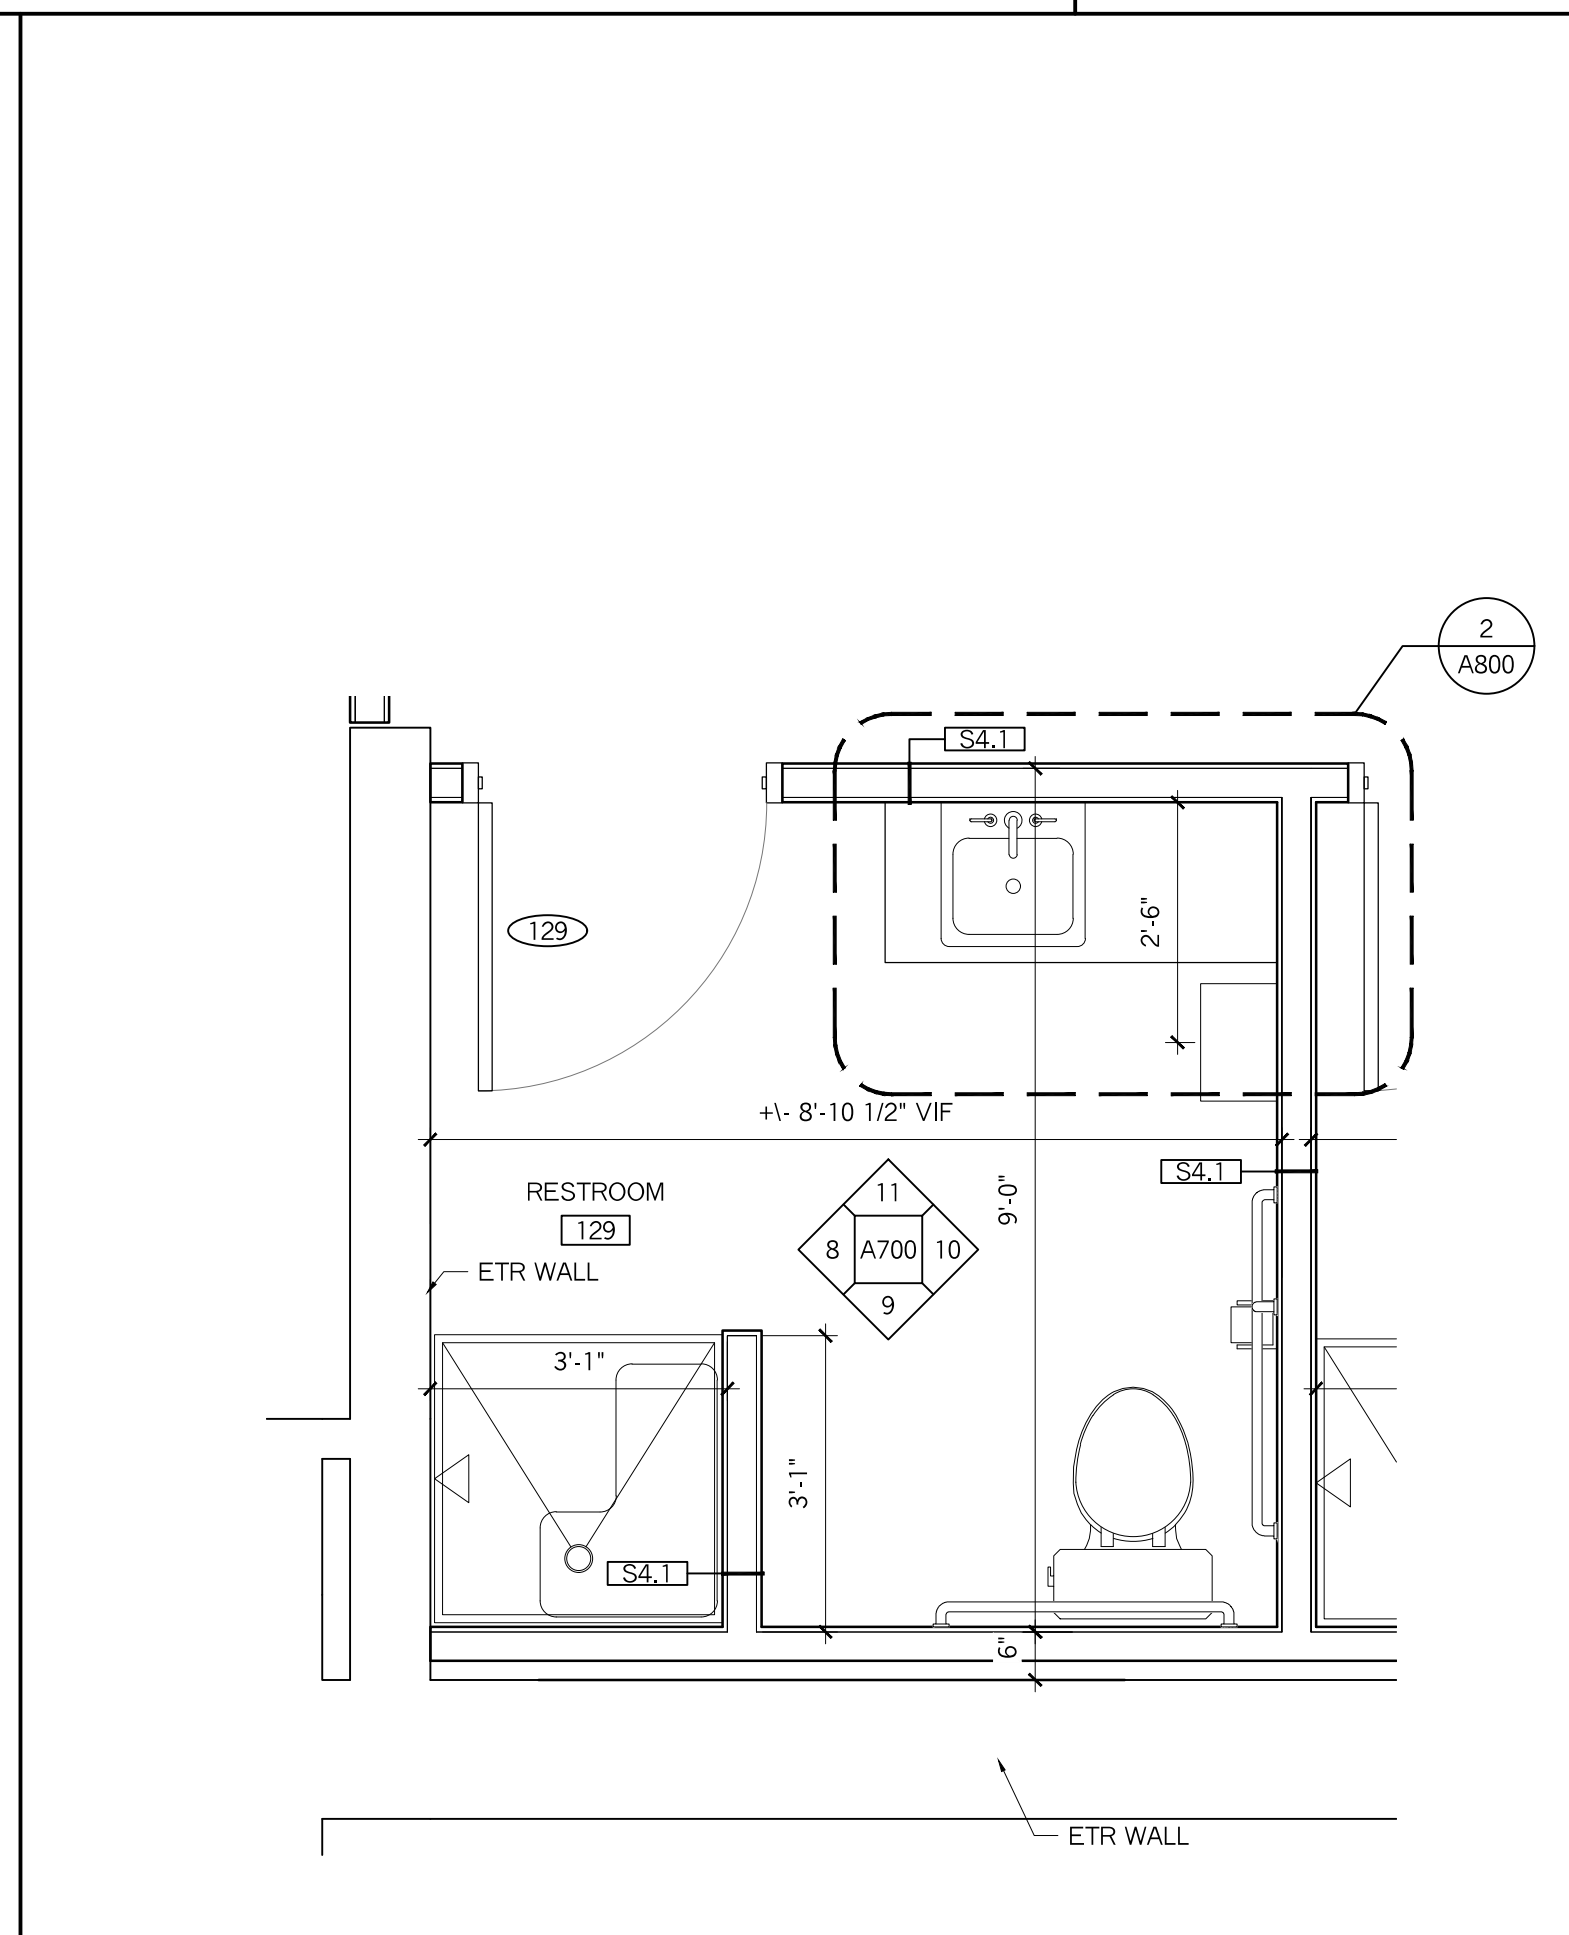

2 ENLARGED PLAN @ RESTROOM 129
1/2" = 1'-0"

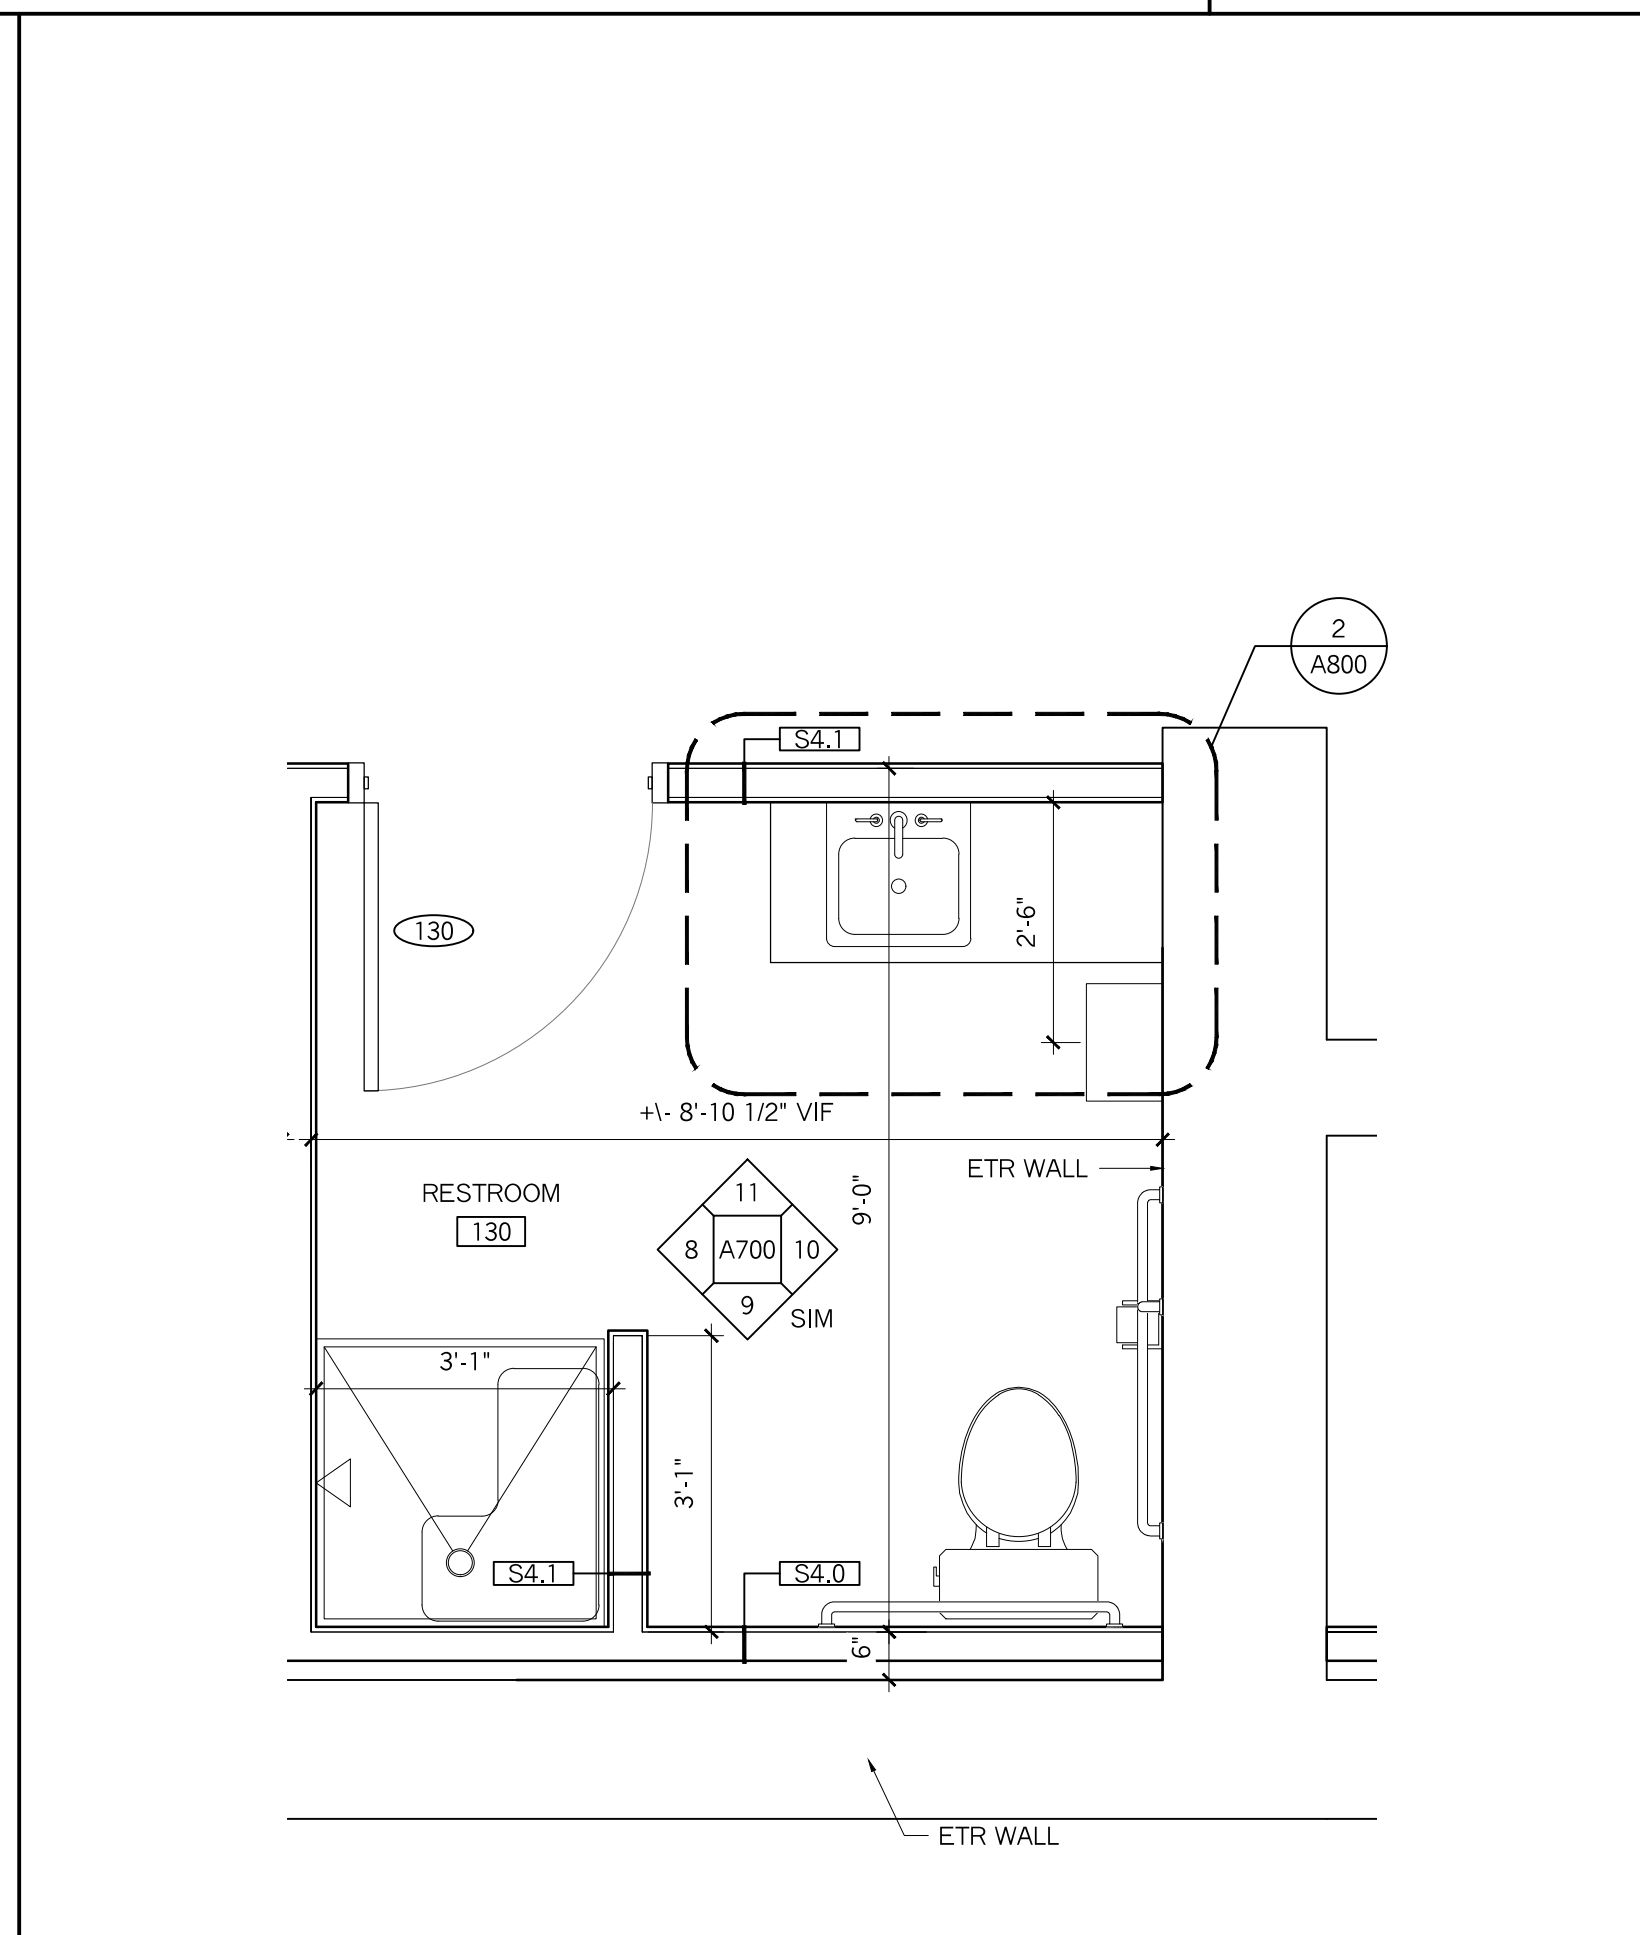

1 ENLARGED PLAN @ RESTROOM 130
1/2" = 1'-0"


GENERAL NOTES

- REFER TO A001 FOR ALL ADA RELATED FIXTURE MOUNTING HEIGHT REQUIREMENTS.
- ALL PLUMBING FIXTURES PROVIDED BY OWNER & INSTALLED BY CONTRACTOR.
- GRAB BARS & FIXTURES PROVIDED BY OWNER & INSTALLED BY CONTRACTOR.

TOILET ACCESSORIES


- 1 36" GRAB BAR
- 2 42" GRAB BAR
- 3 18" GRAB BAR (VERTICAL)
- 4 TOILET TISSUE DISPENSER - BOBRICK B-4288
- 5 SOAP DISPENSER - @ 50" 1/2" AFF (TOP)
- 6 MIRROR, FRAMED 24" WIDE, 36" HIGH - BOBRICK B 290
- 7 PAPER TOWEL DISPENSER - COORDINATE W/ OWNER FOR RE-USE OF EXISTING UNITS
- 8 COAT HOOK - BOBRICK B233 @ 48" AFF (TOP)

A DETAIL
3" = 1'-0"

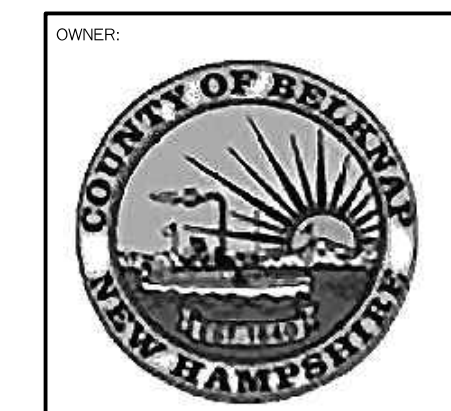

OWNER:
WV Engineering Assoc. PA
11 Park Drive
Laconia, NH 03246
Phone: 603.228.8880

PHONE: 603.228.8880
WWW.SMP.ARCHITECTURE.COM

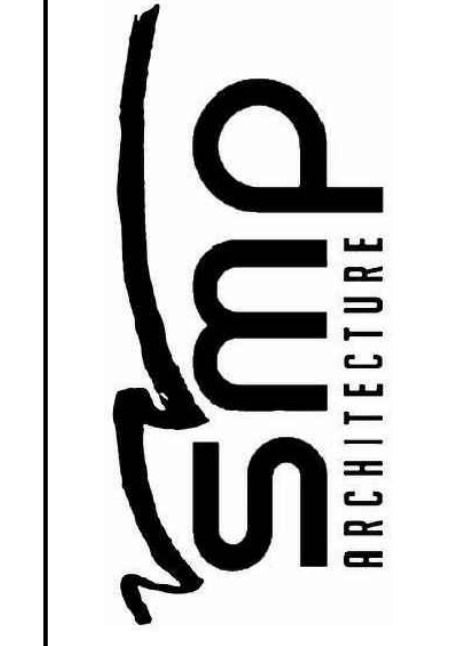


PROJECT: BELKNAP COUNTY SUPERIOR COURT
64 Court St # 5, Laconia, NH 03246
Interior Renovations
RESTROOM INTERIOR ELEVATIONS


DRAWING TITLE:

ISSUED:	DESIGN DEVELOPMENT
JOB NO:	23-011
DRAWN BY:	V.A.D.
CHECKED BY:	A.M.
DATE:	OCTOBER 09, 2023
REVISION	DATE

SHEET NUMBER:
A700
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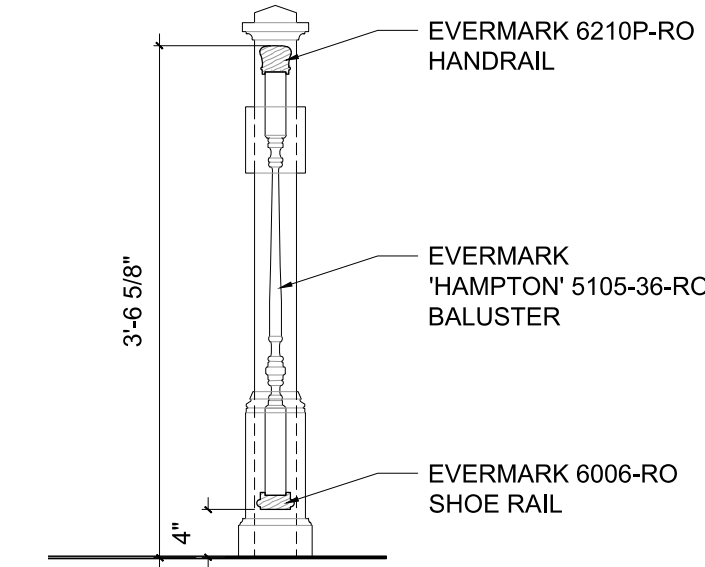


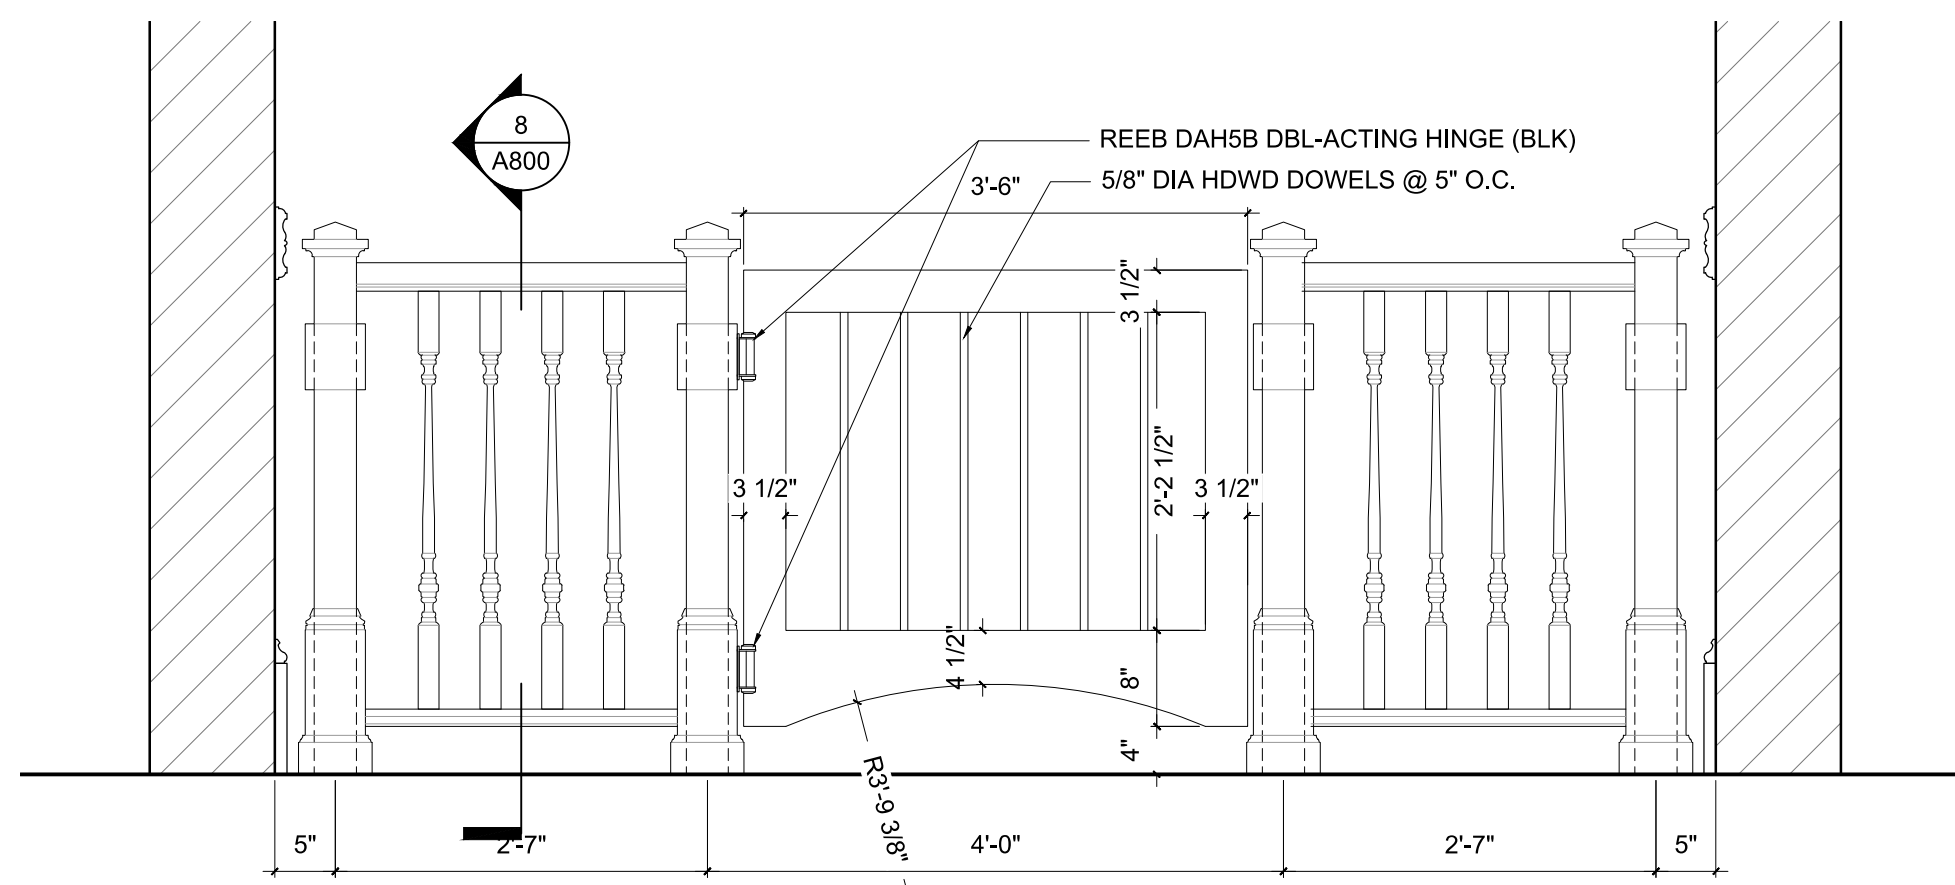10 ELEVATION @ RAILING
3/4" = 1'-0"

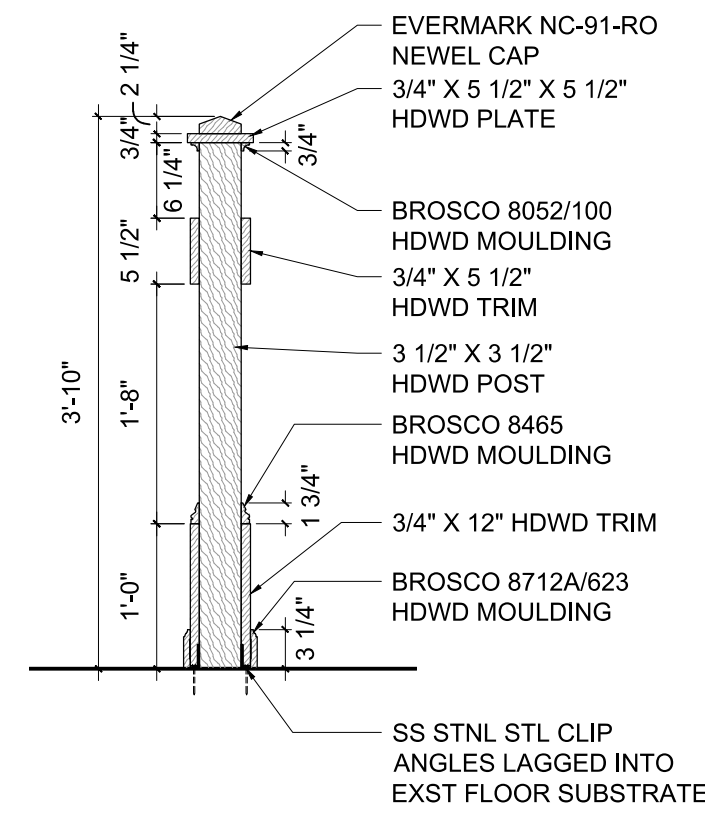


NOTE: ALL HDWD STOCK TO BE RED OAK
- STAIN TO MATCH EXISTING WOODWORK


9 SECTION @ NEWEL POST
3/4" = 1'-0"




8 SECTION @ RAILING
3/4" = 1'-0"

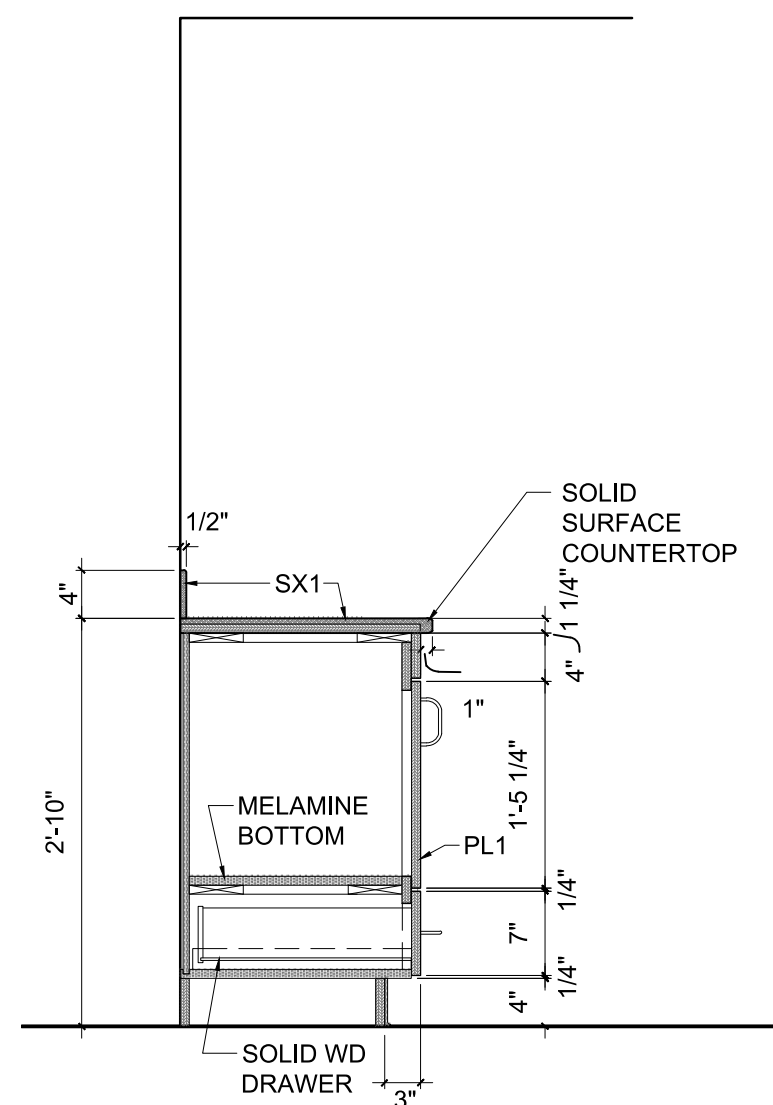


7 SECTION @ RESTROOM VANITY
3/4" = 1'-0"

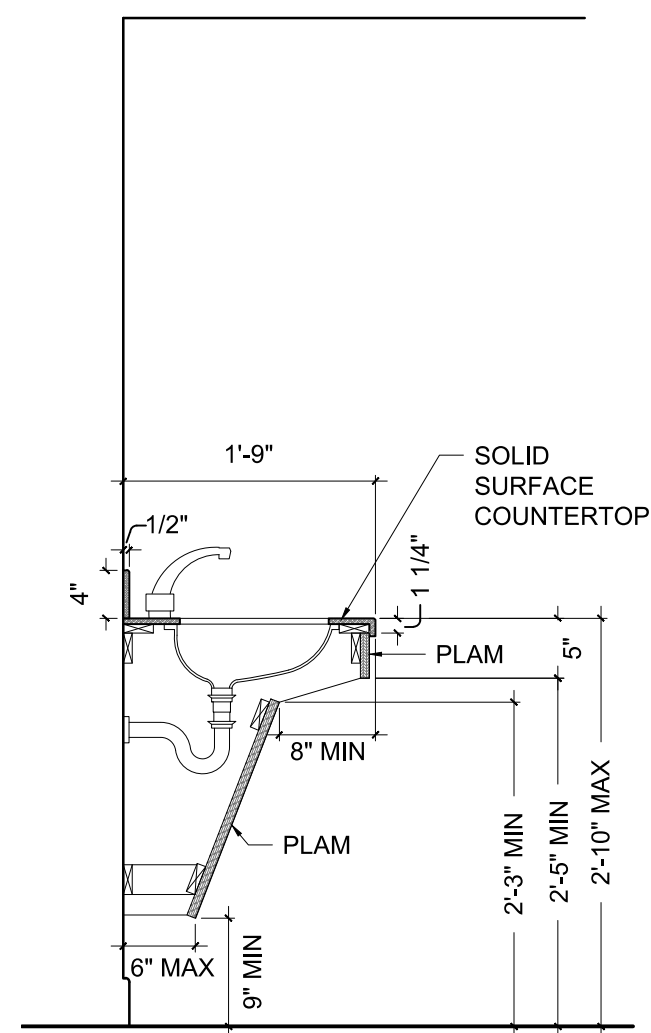


6 SECTION @ RESTROOM VANITY
3/4" = 1'-0"

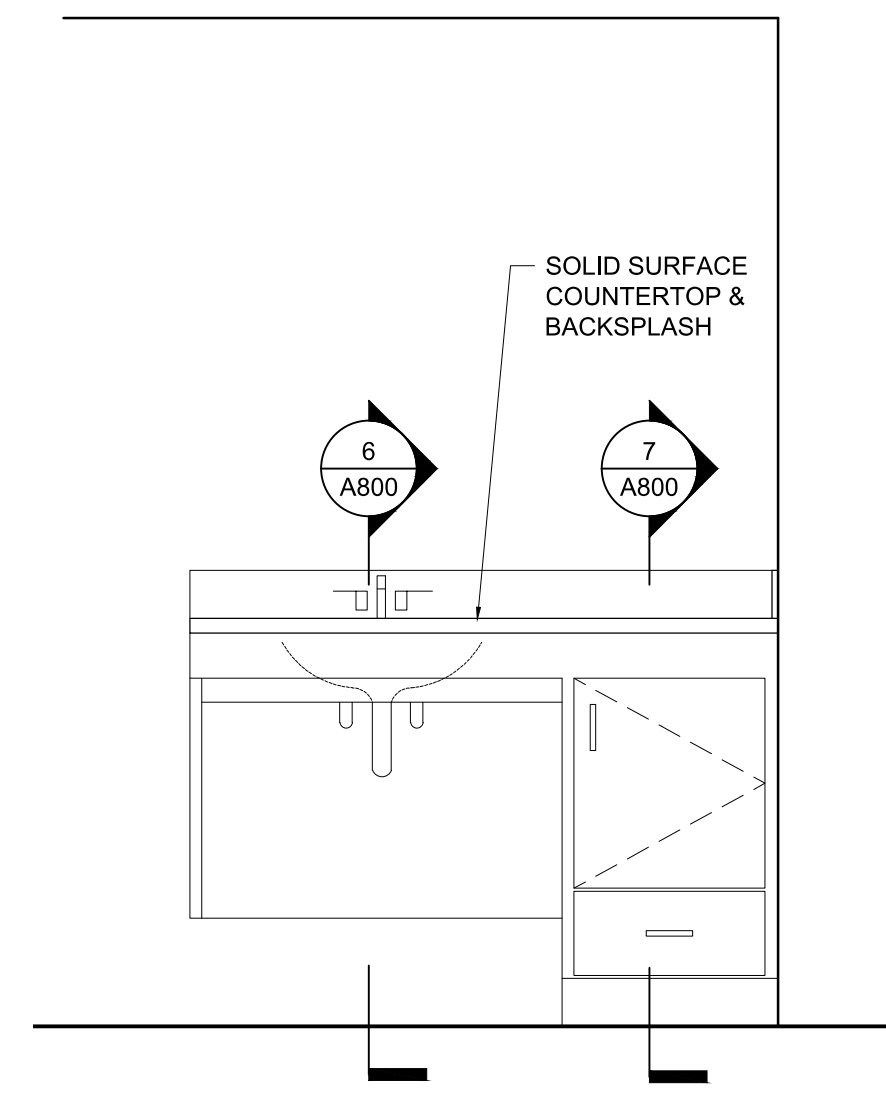


5 ELEVATION @ RESTROOM VANITY
3/4" = 1'-0"

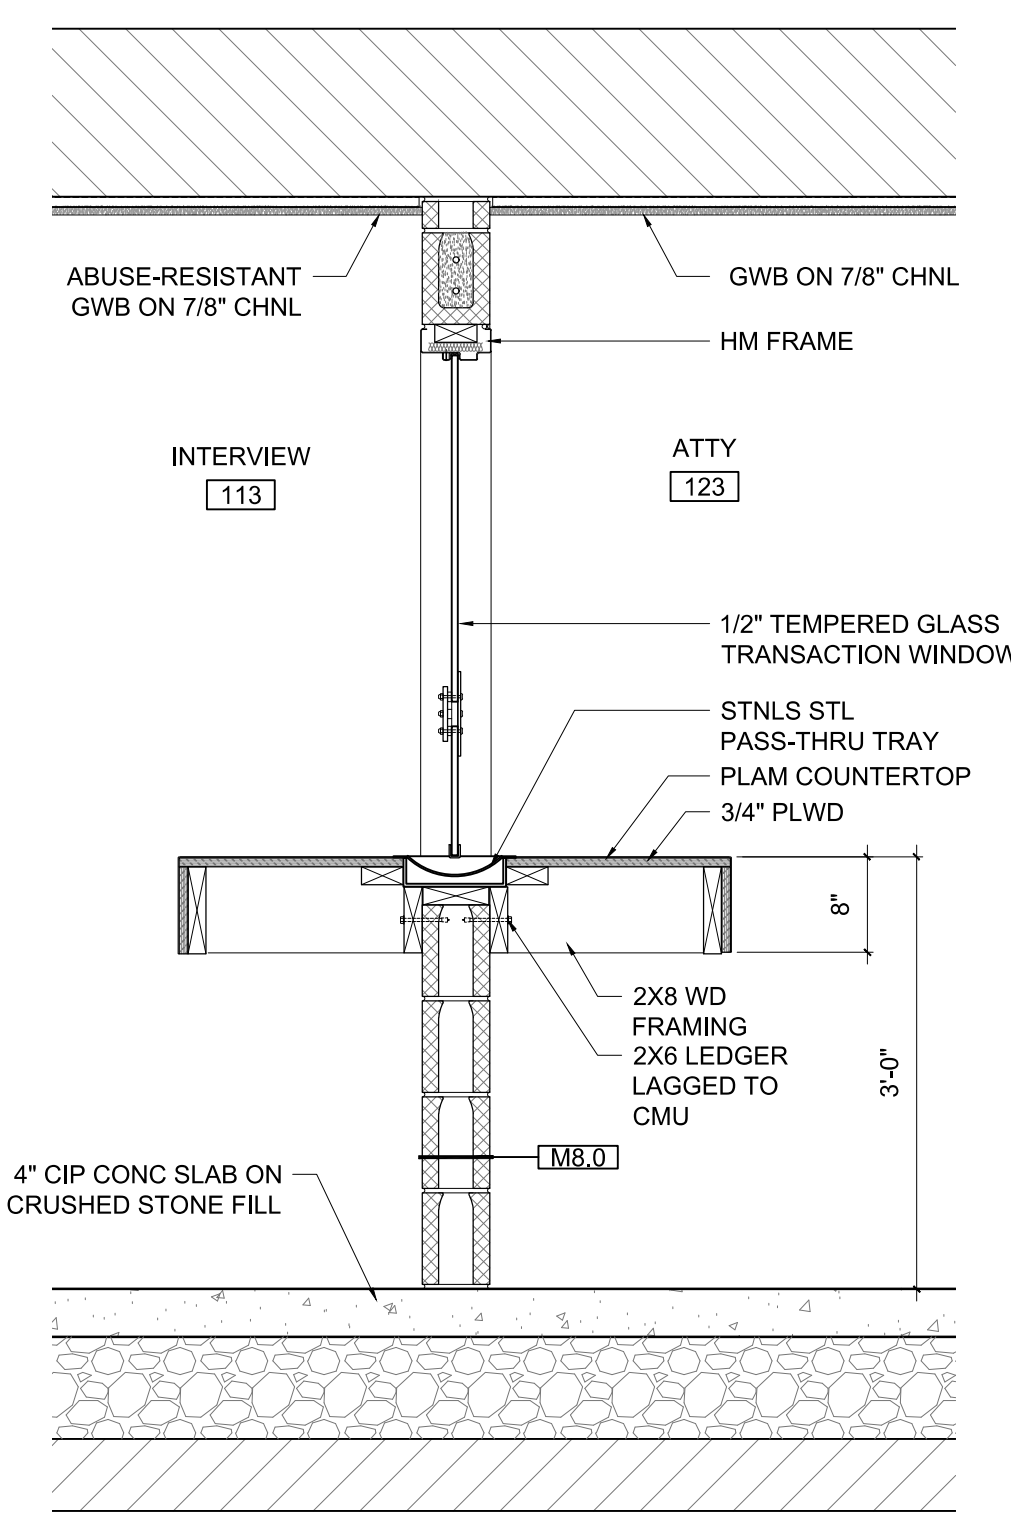


4 SECTION @ INTERVIEW COUNTER
3/4" = 1'-0"

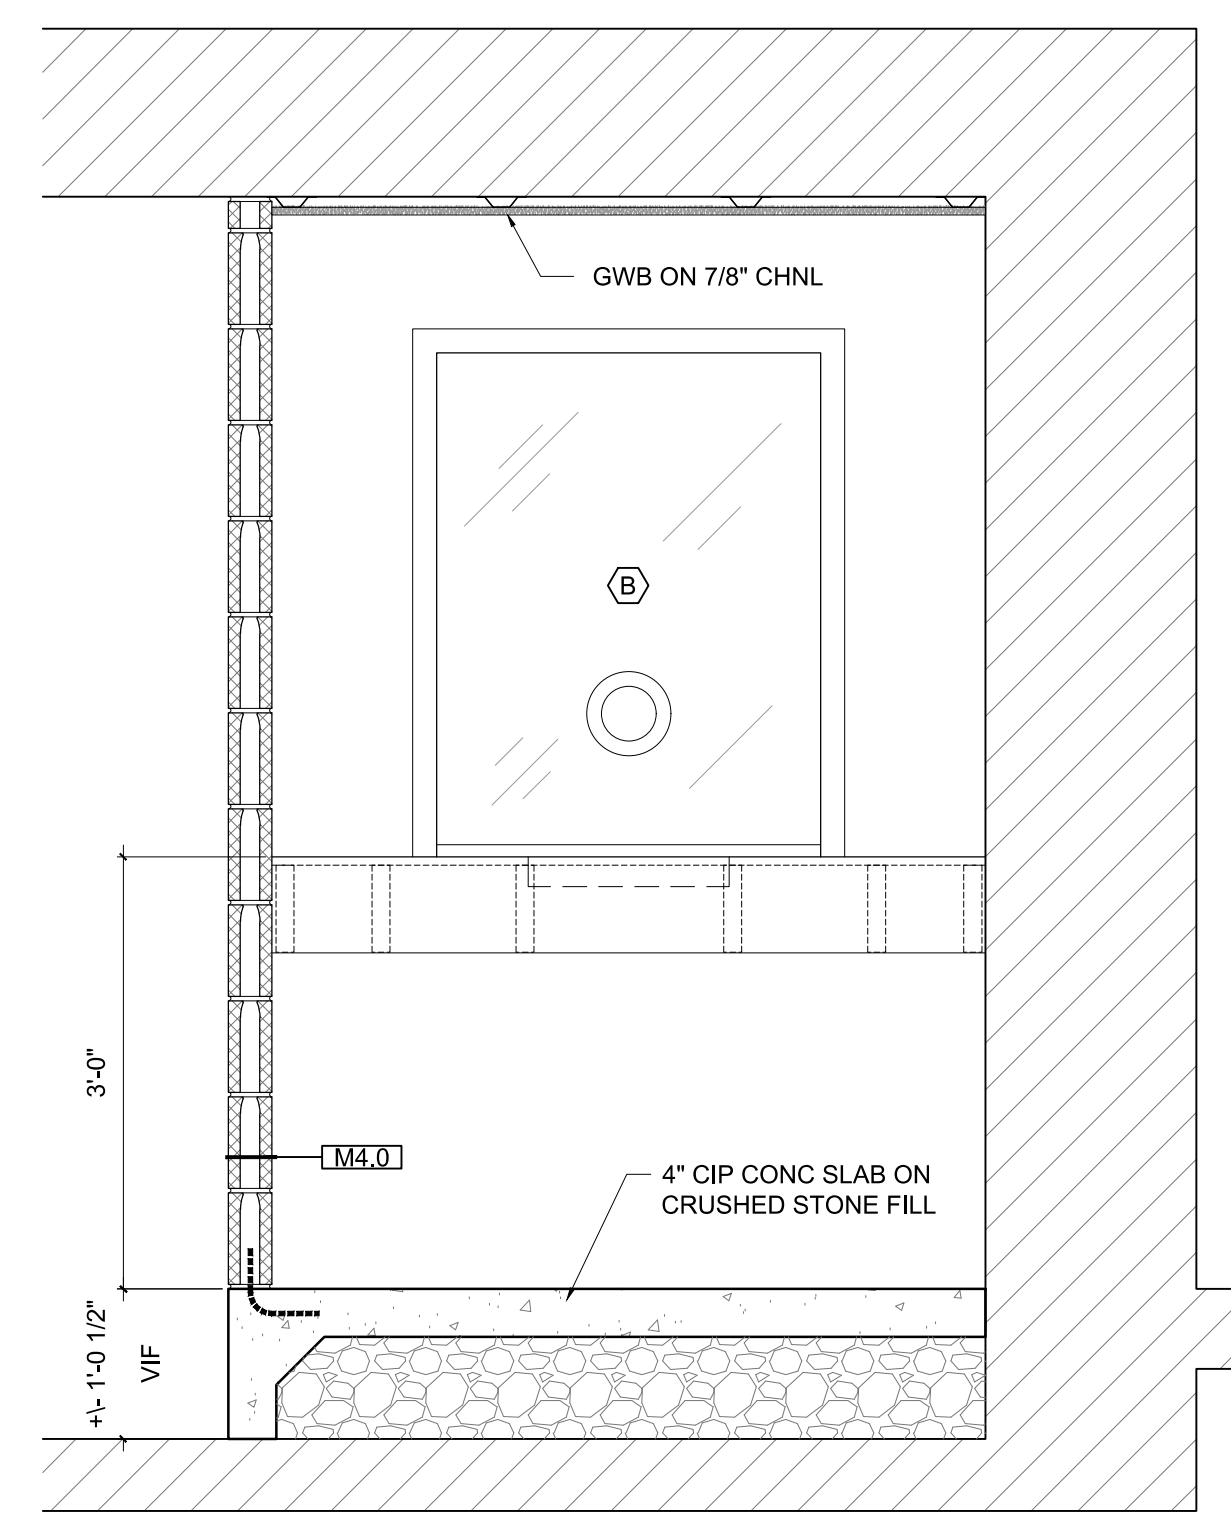


3 ELEVATION @ INTERVIEW COUNTER
3/4" = 1'-0"

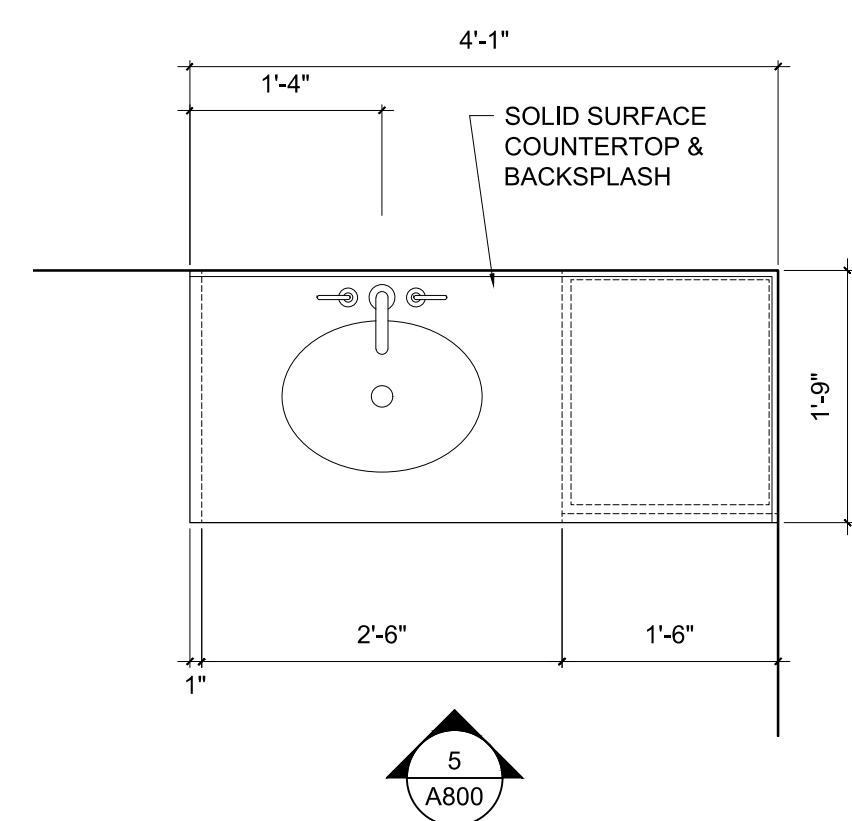

2 PLAN DETAIL @ RESTROOM VANITY
3/4" = 1'-0"

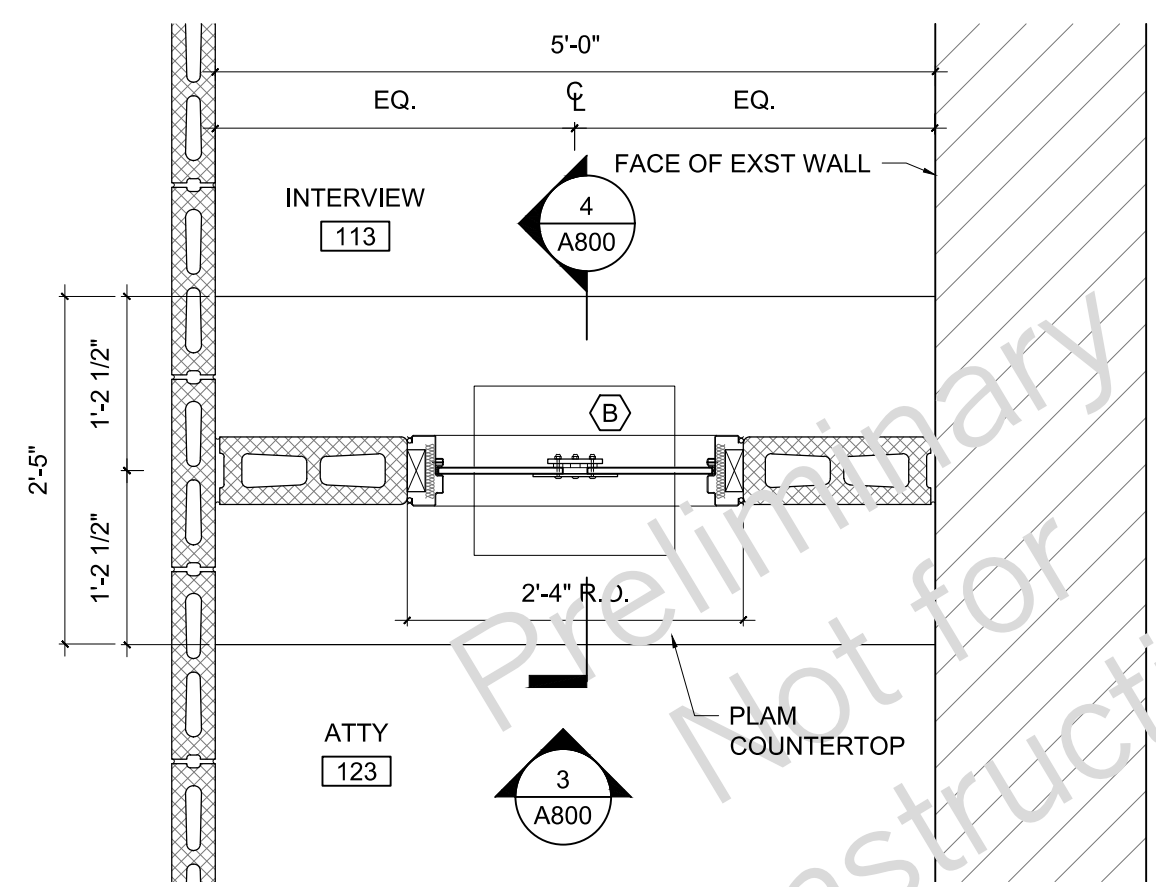

1 PLAN DETAIL @ INTERVIEW COUNTER
3/4" = 1'-0"

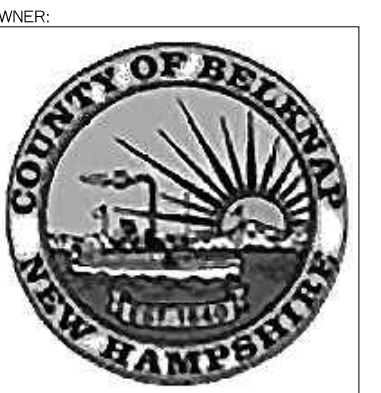

OWNER: County of Belknap
111 State St
Laconia, NH 03246
Phone: 603-528-8880

MEP ENGINEER: WJ Engineering Assoc. PA
111 State St
Laconia, NH 03246
Phone: 603-528-8880





PROJECT: BELKNAP COUNTY SUPERIOR COURT
64 Court St # 5, Laconia, NH 03246
Interior Renovations
CASEWORK DETAILS

PROJECT: BELKNAP COUNTY SUPERIOR COURT
64 Court St # 5, Laconia, NH 03246
Interior Renovations
CASEWORK DETAILS

ISSUED:	DESIGN DEVELOPMENT
JOB NO:	23-011
DRAWN BY:	V.A.D.
CHECKED BY:	A.M.
DATE:	OCTOBER 09, 2023
REVISION	DATE

SHEET NUMBER: **A800**
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GENERAL NOTES:

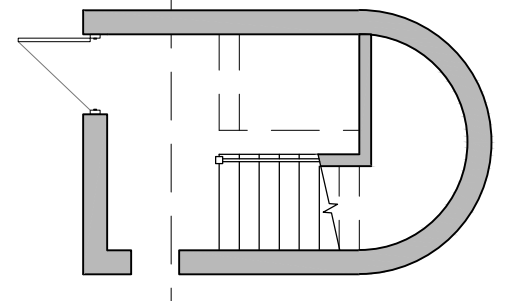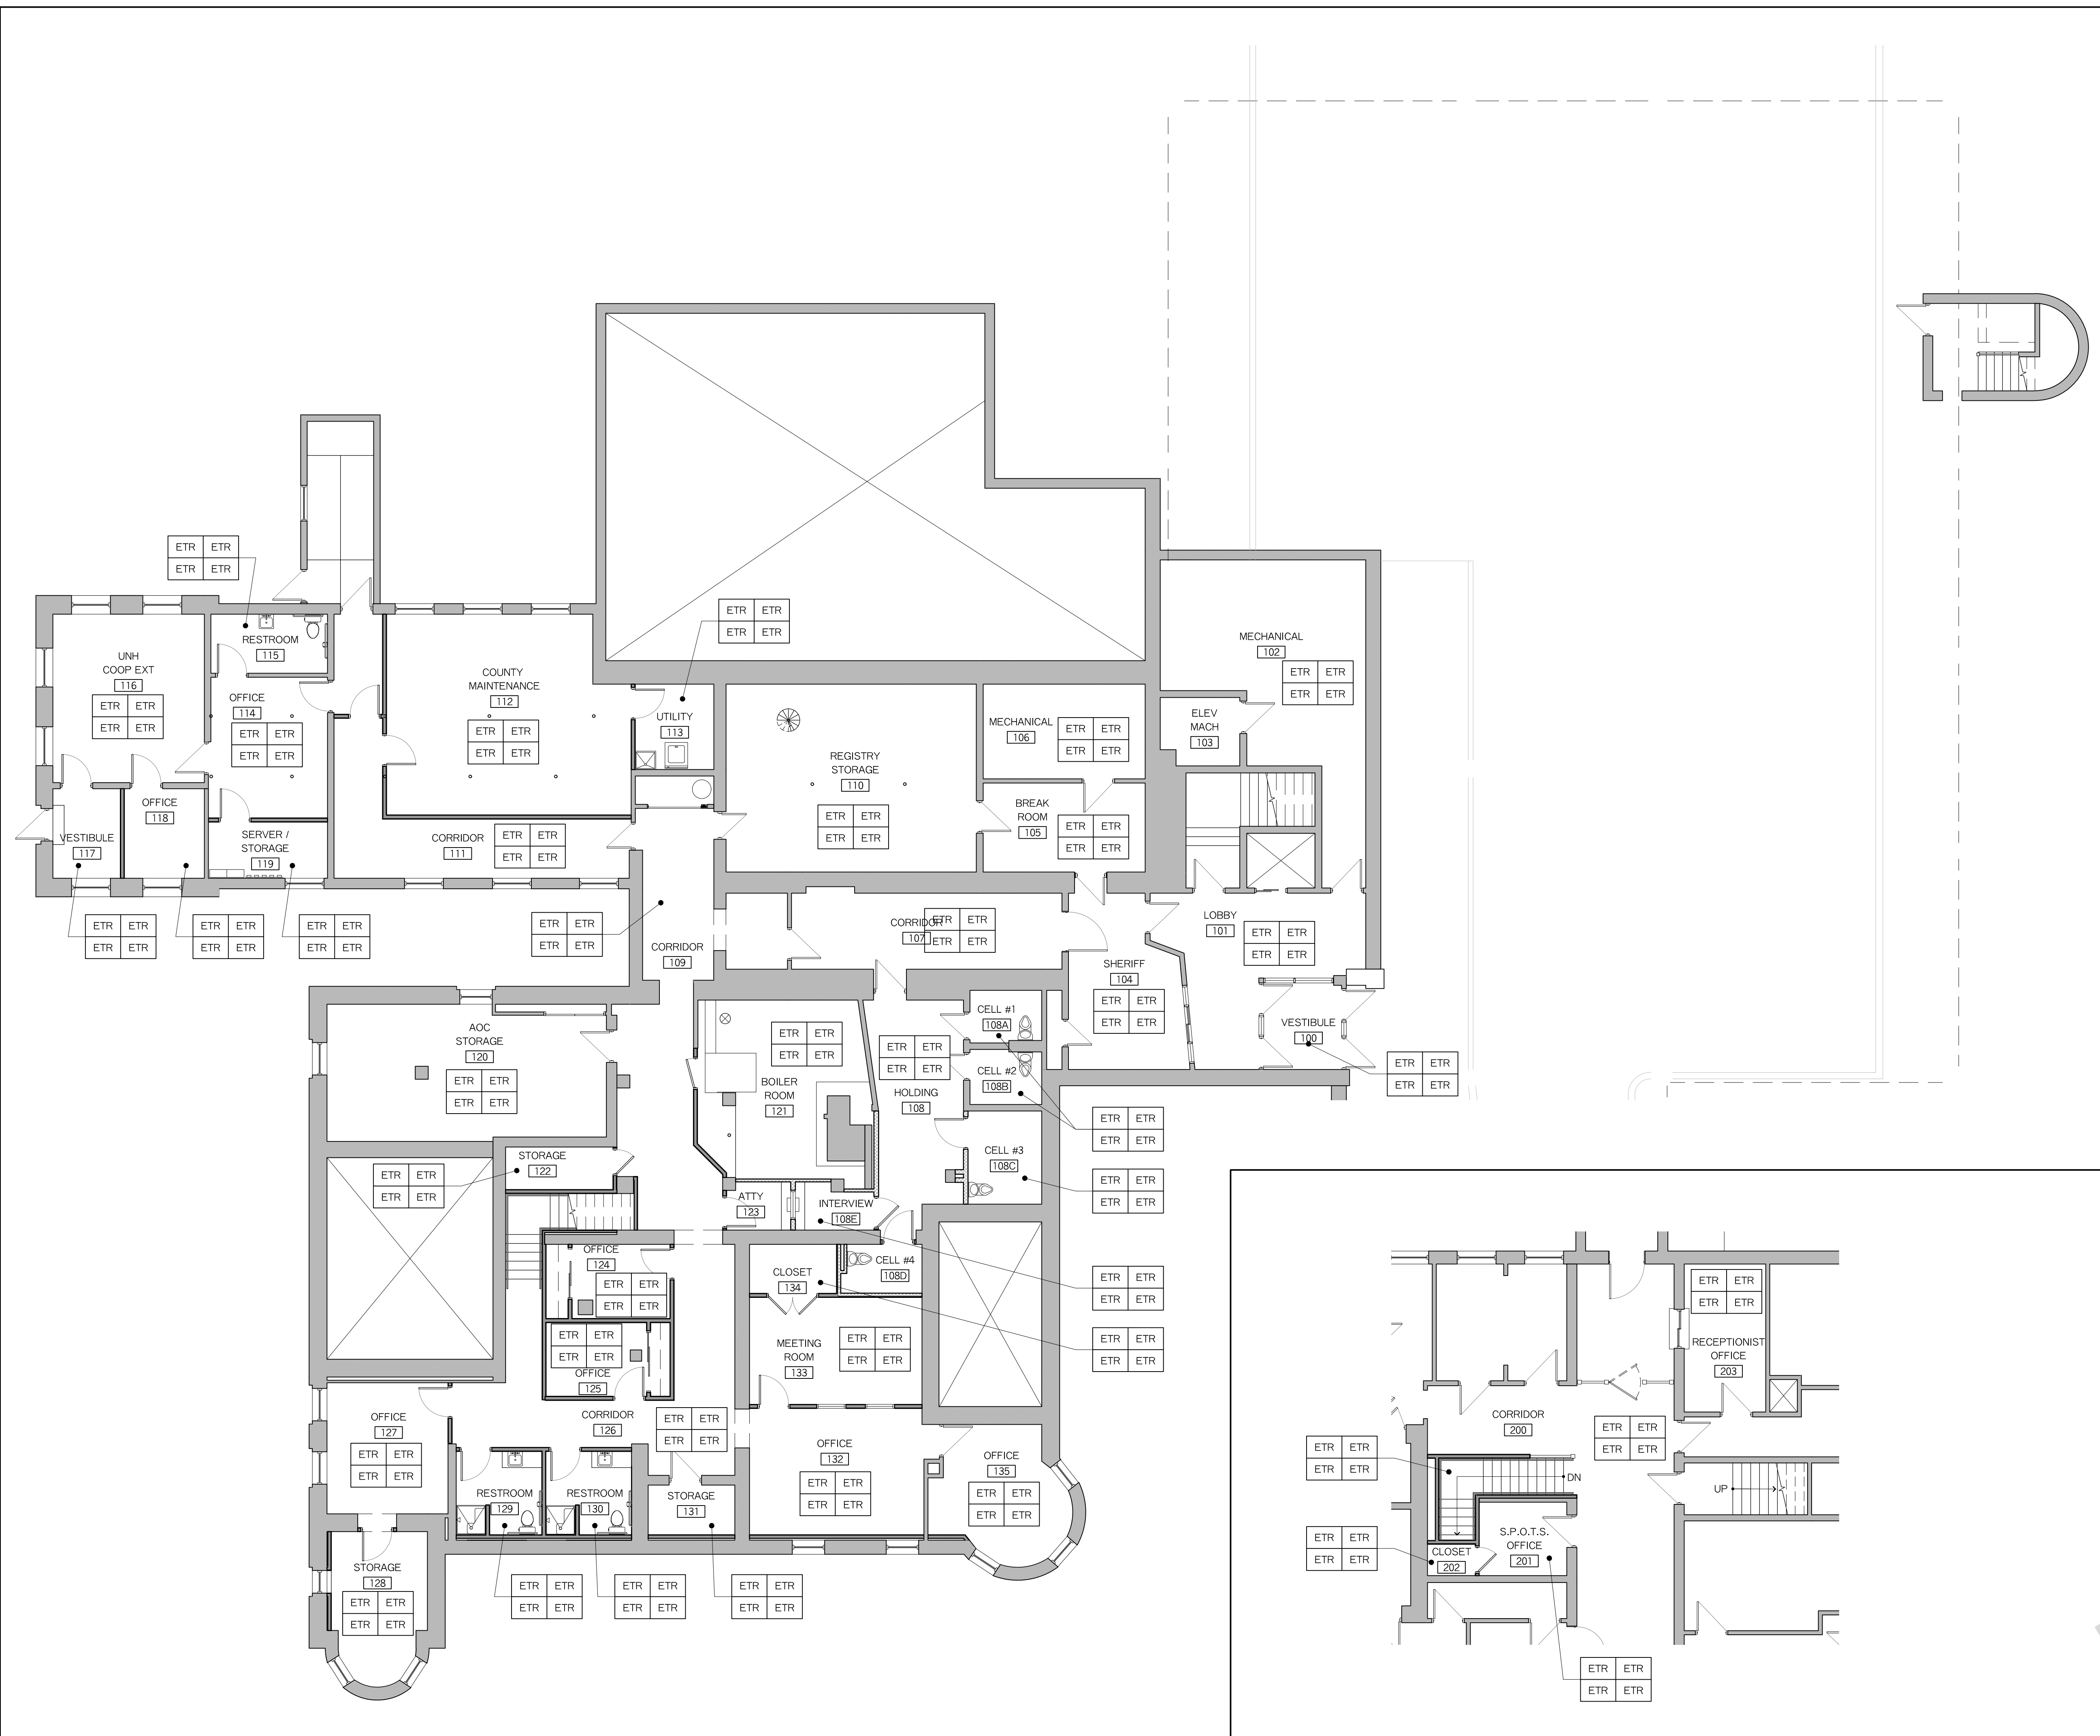1. ALL GYPSUM BOARD CEILINGS WILL BE COLOR WHITE, UNLESS OTHERWISE NOTED.
2. WOOD DOORS SHALL BE FACTORY CLEAR FINISH
3. PROVIDE VINYL TRANSITION STRIPS BETWEEN DISSIMILAR FLOORING MATERIALS.
4. FINISH PRODUCTS LISTED ARE BASIS-OF-DESIGN.
5. FINAL SELECTIONS TO BE DETERMINED BY ARCHITECT & OWNER.
6. FLOOR TILE SHALL BE INSTALLED WITH 1/4" DITRA MAT ANTI-FRACTURE MEMBRANE AND MEET TONA INSTALLATION METHOD FOR GIVEN SUBSTRATE.
7. GROUT JOINTS IN TILE SHALL BE 3/8" UNO.

FINISH KEY:


FLOOR	BASE
WALL	TRIM

FINISH SELECTION:

- CARPET/ CARPET TILE:**
- C1: WALK-OFF - MOHAWK STEP UP II - GT311 'OBSIDIAN' #989
 - C2: MOHAWK - _____
 - C3: MOHAWK - _____
- LUXURY VINYL TILE:**
- LVT1: MATCH EXISTING
- RUBBER FLOORING:**
- RF1: ROPPE - SYMMETRY COLOR # S627 'MARINER'
- PAINT COLORS:**
- ALL PAINTS SHALL BE BENJAMIN MOORE SCUFF-X:
- SATIN FINISH FOR WALLS,
 - SEMI-GLOSS FOR TRIM, AND HM FRAMES
- P1: _____
P2: _____
P3: _____
P4: _____
P5: _____
- BASE**
- B1: MATCH EXISTING (JOHNSONITE 'BLUE LAGOON')
 - B2: 4" VINYL BASE
 - B3: ROPPE - SKIRT COMPATIBLE WITH FLOOR RF1
- PLASTIC LAMINATE:**
- PL1: WILSONART # _____
 - PL2: WILSONART # _____
- SOLID SURFACE:**
- SX1: CORIAN 'LAGUNA'
- HARDWOOD:**
- HDWD1: _____

1 BASEMENT LEVEL REFLECTED CEILING PLAN
1/8" = 1'-0"

2 PARTIAL FIRST FLOOR REFLECTED CEILING PLAN
1/8" = 1'-0"

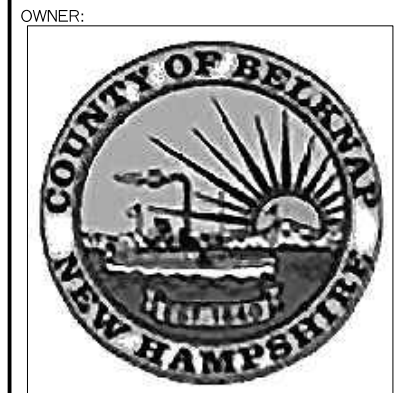

OWNER: WJ Engineering Assoc., PA
 11 Main Street
 Laconia, NH 03246
 Phone: 603.228.8880

OWNER: WJ Engineering Assoc., PA
 11 Main Street
 Laconia, NH 03246
 Phone: 603.228.8880
 WWW.SHEER.COM

PROJECT: BELKNAP COUNTY SUPERIOR COURT
 64 Court St # 5, Laconia, NH 03246
 Interior Renovations

DRAWING TITLE: MAIN LEVEL FINISH PLAN

ISSUED:	DESIGN DEVELOPMENT	23-011
JOB NO:		
DRAWN BY:	V.A.D.	
CHECKED BY:	A.M.	
DATE:	NOVEMBER 09, 2023	
REVISION		DATE

SHEET NUMBER: **A900**
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Preliminary
 Not for
 Construction